HOFHEIMER HALL SECOND FLOOR RENOVATION

EVMS GYNECOLOGY

825 FAIRFAX AVENUE NORFOLK, VA 23507

FINAL SUBMITTAL 03/26/24

PROJECT INFORMATION

HOFHEIMER HALL SECOND FLOOR RENOVATIONS FOR GYNECOLOGY NAME OF PROJECT:

OWNER: EASTERN VIRGINIA MEDICAL SCHOOL

PROJECT DESCRIPTION: HOFHEIMER HALL IS AN EXISTING BUILDING CONSTRUCTED IN 1985. THE


GROSS BUILDING. AREA IS 106,238 SQUARE FEET SPREAD OVER 7 FLOORS THIS PROJECT INCLUDES THE INTERIOR RENOVATION OF PORTIONS OF THE SECOND FLOOR FOR THE EVMS GYNECOLOGY PRACTICE.

ZONING: INSTITUTIONAL - CAMPUS DISTRICT (IN-C)


HAZARDOUS MATERIALS GENERAL NOTES

- A HAZARDOUS MATERIALS INSPECTION WAS PERFORMED. THE SURVEY/INSPECTION REPORT IS AVAILABLE TO THE CONTRACTOR(S) FOR THEIR INFORMATION. THE WORK WILL NOT REQUIRE THE IF DURING THE WORK SUSPECT MATERIALS ARE UNCOVERED. THE CONTRACTOR SHALL STOP WORK UNTIL THE MATERIAL IS PROPERLY IDENTIFIED AND ADDRESSED
- 2. THE CONTRACTOR SHALL BE RESPONSIBLE FOR DEVELOPING A PROJECT APPROACH BY COORDINATING WITH VARIOUS SUBCONTRACTORS. THE SPECIFIC WORK TECHNIQUES AND PRACTICES SELECTED TO EXECUTE THE CONTRACT WILL DETERMINE THE ABATEMENT MEASURES REQUIRED. THE PROJECT APPROACH SHALL BE BASED ON HISTORICAL DATA AND EXPERIENCE WITH PROJECTS OF SIMILAR
- 3. EXISTING PAINT HAS BEEN DETERMINED TO CONTAIN LEAD, CADMIUM AND CHROMIUM CONCENTRATIONS ABOVE THE LABORATORY'S MINIMUM DETECTION LIMIT. PERFORM WORK IN ACCORDANCE WITH SPECIFICATION SECTION 02 8313 "LEAD, CADMIUM, AND CHROMIUM IN CONSTRUCTION". CONSTRUCTION STANDARDS FOR LEAD, CADMIUM AND CHROMIUM ARE 29 CFR 1926.62, CFR 29 1926.1127 AND 29 CFR
- 4. TOXICITY CHARACTERISTIC LEACHING PROCEDURE (TCLP) TESTING ON EXISTING PAINTED BUILDING MATERIALS. WHEN DEMOLISHED AS COMPONENTS OF AN ASSEMBLY TYPICALLY RETURN RESULTS STRIPPING, BLASTING, SCRAPING OR OTHER METHODS THAT REMOVE THE PAINT COATING FROM THE EXISTING SUBSTRATE, OR PRODUCES A WASTE RESULTING PRIMARILY OF PAINT MATERIAL, WILL RESULT IN WASTE CLASSIFIED AS HAZARDOUS. THE CONTRACTOR SHALL COORDINATE THE WORK PROCEDURES TO DETERMINE THE ANTICIPATED WASTE STREAM. CONTRACTOR IS RESPONSIBLE FOR ALL COSTS ASSOCIATED WITH DISPOSAL OF WASTE GENERATED FROM THE WORK.
- 5. ALL LIGHT BALLASTS WITHOUT "NO-PCB" MARKINGS SHALL BE CONSIDERED PCB CONTAINING. LIGHT BALLASTS WITHOUT "NO-PCB" MARKINGS, ALL FLOURESCENT LIGHT TUBES, AND ALL THERMOSTATS SHALL BE REMOVED IN ACCORDANCE WITH SPECIFICATION SECTION 02 8416 "HANDLING OF LIGHTING BALLASTS AND LAMPS CONTAINING PCBs AND MERCURY". FOR BIDDING PURPOSES, ASSUME ALL FLUORESCENT LIGHT TUBES CONTAIN MERCURY VAPOR AND MERCURY. SEE ELECTRICAL DEMOLITION DRAWINGS FOR LOCATIONS AND QUANTITIES.

VICINITY MAP

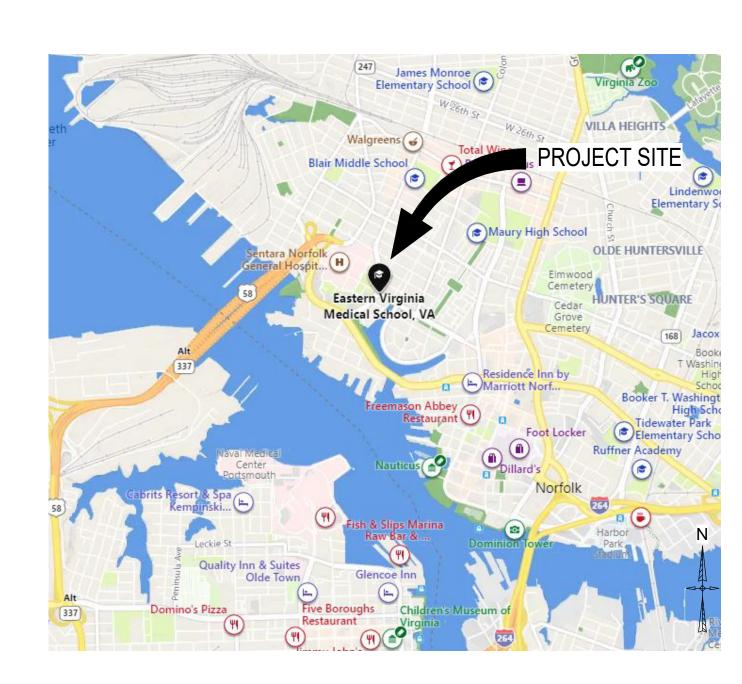

SITE MAP

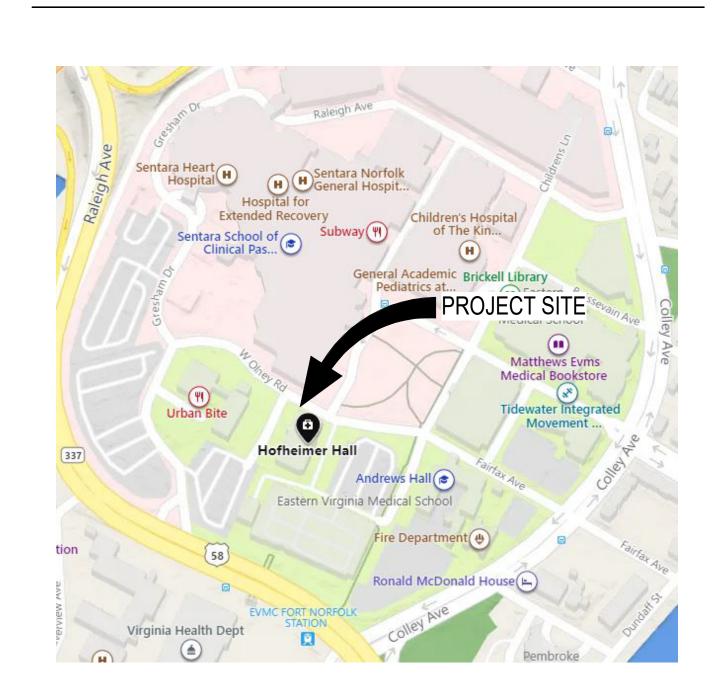

SHEET INDEX

SHEET NUMBER SHEET NAME **GENERAL COVER SHEET** BUILDING CODE SUMMARY & CONTRACTOR LAYDOWN SECOND FLOOR LIFE SAFETY PLAN ARCHITECTURAL

ARCHITECTURAL LEGEND, NOTES AND ABBREVIATIONS SECOND FLOOR DEMOLITION PLAN SECOND FLOOR FLOOR PLAN SECOND FLOOR REFLECTED CEILING PLAN

TOILET ROOM PLANS AND ELEVATIONS **ENLARGED PLANS & INTERIOR ELEVATIONS ENLARGED PLANS & INTERIOR ELEVATIONS ENLARGED PLANS & INTERIOR ELEVATIONS**

PARTITION TYPES AND DETAILS **CEILING DETAILS** DOOR SCHEDULE AND DOOR / FRAME TYPES

INTERIORS SECOND FLOOR FINISH PLAN FINISH SCHEDULE & LEGEND SECOND FLOOR SIGNAGE PLAN SIGNAGE DETAILS

FIRE PROTECTION

FIRE PROTECTION LEGEND, NOTES AND DETAILS SECOND FLOOR PLAN - FIRE PROTECTION DEMOLITION SECOND FLOOR PLAN - FIRE PROTECTION

SECOND FLOOR FURNITURE PLAN

PLUMBING

P-001 PLUMBING LEGEND FIRST FLOOR DEMOLITION PLAN SECOND FLOOR DEMOLITION PLAN FIRST FLOOR PLAN SECOND FLOOR PLAN SCHEDULES P-601

SHEET NUMBER SHEET NAME

MECHANICAL

MECHANICAL LEGEND MECHANICAL GENERAL NOTES & SCHEDULES SECOND FLOOR DEMOLITION PLAN

SECOND FLOOR DUCTWORK PLAN SECOND FLOOR PIPING PLAN

SCHEDULES CONTROLS

ELECTRICAL LEGEND, NOTES AND ABBREVIATIONS

SECOND FLOOR ELECTRICAL DEMOLITION PLAN - LIGHTING SECOND FLOOR ELECTRICAL DEMOLITION PLAN - POWER AND TELECOM

SECOND FLOOR LIGHTING PLAN LIGHTING FIXTURE SCHEDULE

SECOND FLOOR POWER AND TELECOMMUNICATIONS PLAN

POWER AND TELECOMMUNICATIONS DETAILS

SCHEDULES

EVMS GYNECOLOGY

HOFHEIMER HALL **SECOND FLOOR RENOVATION**

825 FAIRFAX AVENUE NORFOLK, VA 23507

DESIGNER

CLARKNEXSEN

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PROFESSIONAL SEAL

03/26/24 FINAL SUBMITTAL


COVER SHEET

G-001

DESIGN: DLS DRAWN: TSM REVIEW: DLS

AT SOUTHWEST CORNER OF BUILDING

OR AS COORDINATED WITH OWNER.

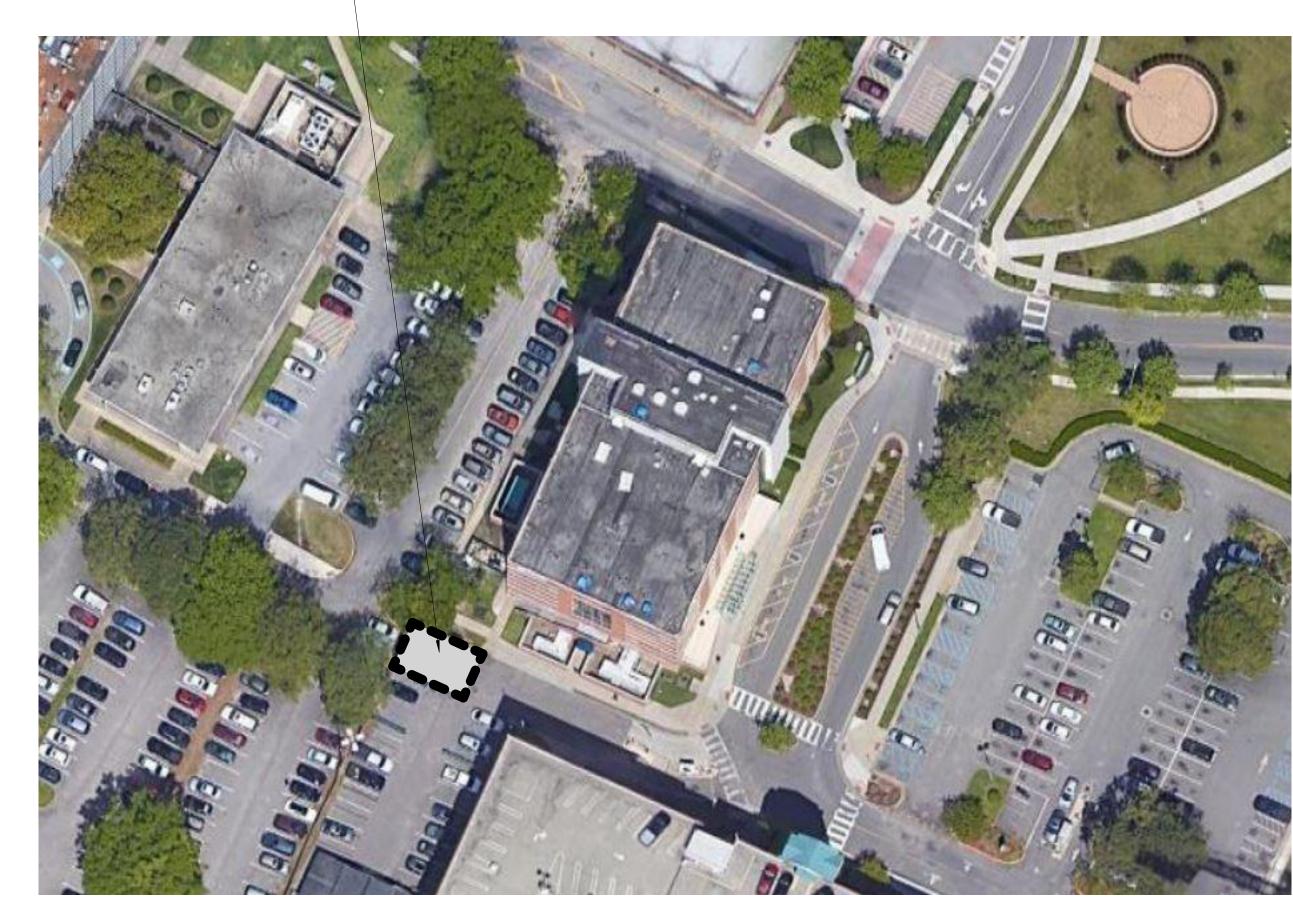

2

CONTRACTOR LAYDOWN AREA

NOT TO SCALE

CODE INFORMATION

1. APPLICABLE CODES

VIRGINIA UNIFORM STATEWIDE BUILDING CODE (USBC) 2018 VIRGINIA CONSTRUCTION CODE (VCC) 2018 VIRGINIA EXISTING BUILDING CODE (VEBC)

2010 ADAAG - ADA ACCESSIBILITY GUIDELINES FOR BUILDINGS AND FACILITIES

2. WORK CLASSIFICATION

LEVEL II ALTERATION (SECTION 601.2.2, VEBC)

3. OCCUPANCY CLASSIFICATION

MIXED OCCUPANCY, SEPARATED (SECTION 508.4, VCC)

BUSINESS GROUP 'B' (SECTION 304.1, VCC) WITH ACCESSORY ASSEMBLY GROUP 'A-3' (SECTION 508.2, VCC) ASSEMBLY GROUP 'A-3' (SECTION 303.4, VCC)

4. TYPE OF CONSTRUCTION

TYPE IIA

BUILDING NOT EQUIPPED THROUGHOUT WITH AUTOMATIC SPRINKLER SYSTEM. AUTOMATIC SPRINKLER REQUIREMENTS OF 903.3.1.1 TO BE PROVIDED FOR THE SECOND FLOOR RENOVATION AREAS AS PART OF PROJECT WORK SCOPE.

5. BUILDING HEIGHT

74'-6" (7TH STORY) HIGHEST OCCUPIED FLOOR LEVEL HEIGHT: TOTAL BUILDING HEIGHT ABOVE GRADE: : 107'-4 1/2"

6. BUILDING AREA (PER VCC)

FIRST FLOOR: 16,063 SF SECOND FLOOR: 14,720 SF LEVEL II ALTERATION AREA: 5,168 SF 9,552 SF AREA NOT IN CONTRACT: THIRD FLOOR: FOURTH FLOOR: 15,091 SF 15,091 SF FIFTH FLOOR: 15,091 SF SIXTH FLOOR: 15,091 SF **SEVENTH FLOORS:** 106,238 SF

7. MINIMUM FIRE RESISTANCE RATING & CLASSIFICATION REQUIREMENTS

BUILDING ELEMENTS, EXISTING

STAIRWAY AND EXITWAY ENCLOSURES: 2 HR 2 HR SHAFTS AND ELEVATOR HOISTWAYS: **EXIT ACCESS CORRIDORS:** 1 HR COLUMNS: 2 HR 1.5 HR BEAMS: 1 HR ROOF CONSTRUCTION:

ROOF COVERING FIRE CLASSIFICATION (TABLE 1505.1, VCC): CLASS B

INTERIOR FINISHES (CHAPTER 8, VCC), NON-SPRINKLERED

WALLS AND CEILINGS CLASS A EXIT STAIRS, RAMPS & PASSAGEWAYS: CLASS B CORRIDORS: CLASS C ROOMS & ENCLOSED SPACES:

FLOORING: NFPA 253, CLASS II **EXIT ENCLOSURES:** EXIT ACCESS CORRIDORS & OPEN ADJ. SPACES: NFPA 253, CLASS II ALL OTHERS: NONE

8. MEANS OF EGRESS

EGRESS CAPACITY

CORRIDOR CAPACITY FACTOR: 0.2" PER PERSON (SECTION 1005.3.2, VCC) MINIMUM CORRIDOR WIDTH: 44" (TABLE 1020.2, VCC) 72" (TABLE 1020.2, VCC) OUTPATIENT GURNEY TRAFFIC: DOOR CAPACITY FACTOR: 0.2" PER PERSON (1005.3.2, VCC) MINIMUM DOOR WIDTH: 32" (SECTION 1008.1.1, VCC)

ARRANGEMENT OF EXITS & TRAVEL DISTANCE

MINIMUM NUMBER OF EXITS REQUIRED (TABLE 106.3.1, VCC): 2 (1-500 OCCUPANTS) MAXIMUM EXIT TRAVEL DISTANCE (TABLE 1017.2, VCC): 200 FEET MAXIMUM COMMON PATH OF TRAVEL (TABLE 1006.2.1, VCC): 75 FEET MAXIMUM DEAD END CORRIDOR LENGTH (SECTION 1020.4, VCC): 20 FEET

NOTES:

-AS PART OF THIS RENOVATION, THERE IS NO CHANGE TO THE PLAN ARRANGEMENT, EGRESS CAPACITY, OCCUPANCY TYPE, OR OCCUPANT LOAD FOR AREAS OTHER THAN THE SECOND FLOOR . THEREFORE, LIFE SAFETY PLANS AND OCCUPANCY CALCULATIONS ARE NOT SHOWN FOR THESE AREAS.

- CONTRACTOR TO PROVIDE INTERIM LIFE SAFETY MEASURES FOR OCCUPIED AREAS OF THE BUILDING AFFECTED DURING

- WHERE EXISTING FIREPROOFING IS DISTURBED DURING DEMOLITON / CONSTRUCTION, PATCH TO MATCH EXISTING CONSTRUCTION AND RATING.

EVMS GYNECOLOGY

HOFHEIMER HALL **SECOND FLOOR RENOVATION**

825 FAIRFAX AVENUE NORFOLK, VA 23507

DESIGNER

CLARKNEXSEN

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PROFESSIONAL SEAL

SUBMITTAL 03/26/24


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REVISIONS

BUILDING CODE SUMMARY & CONTRACTOR LAYDOWN

GI101


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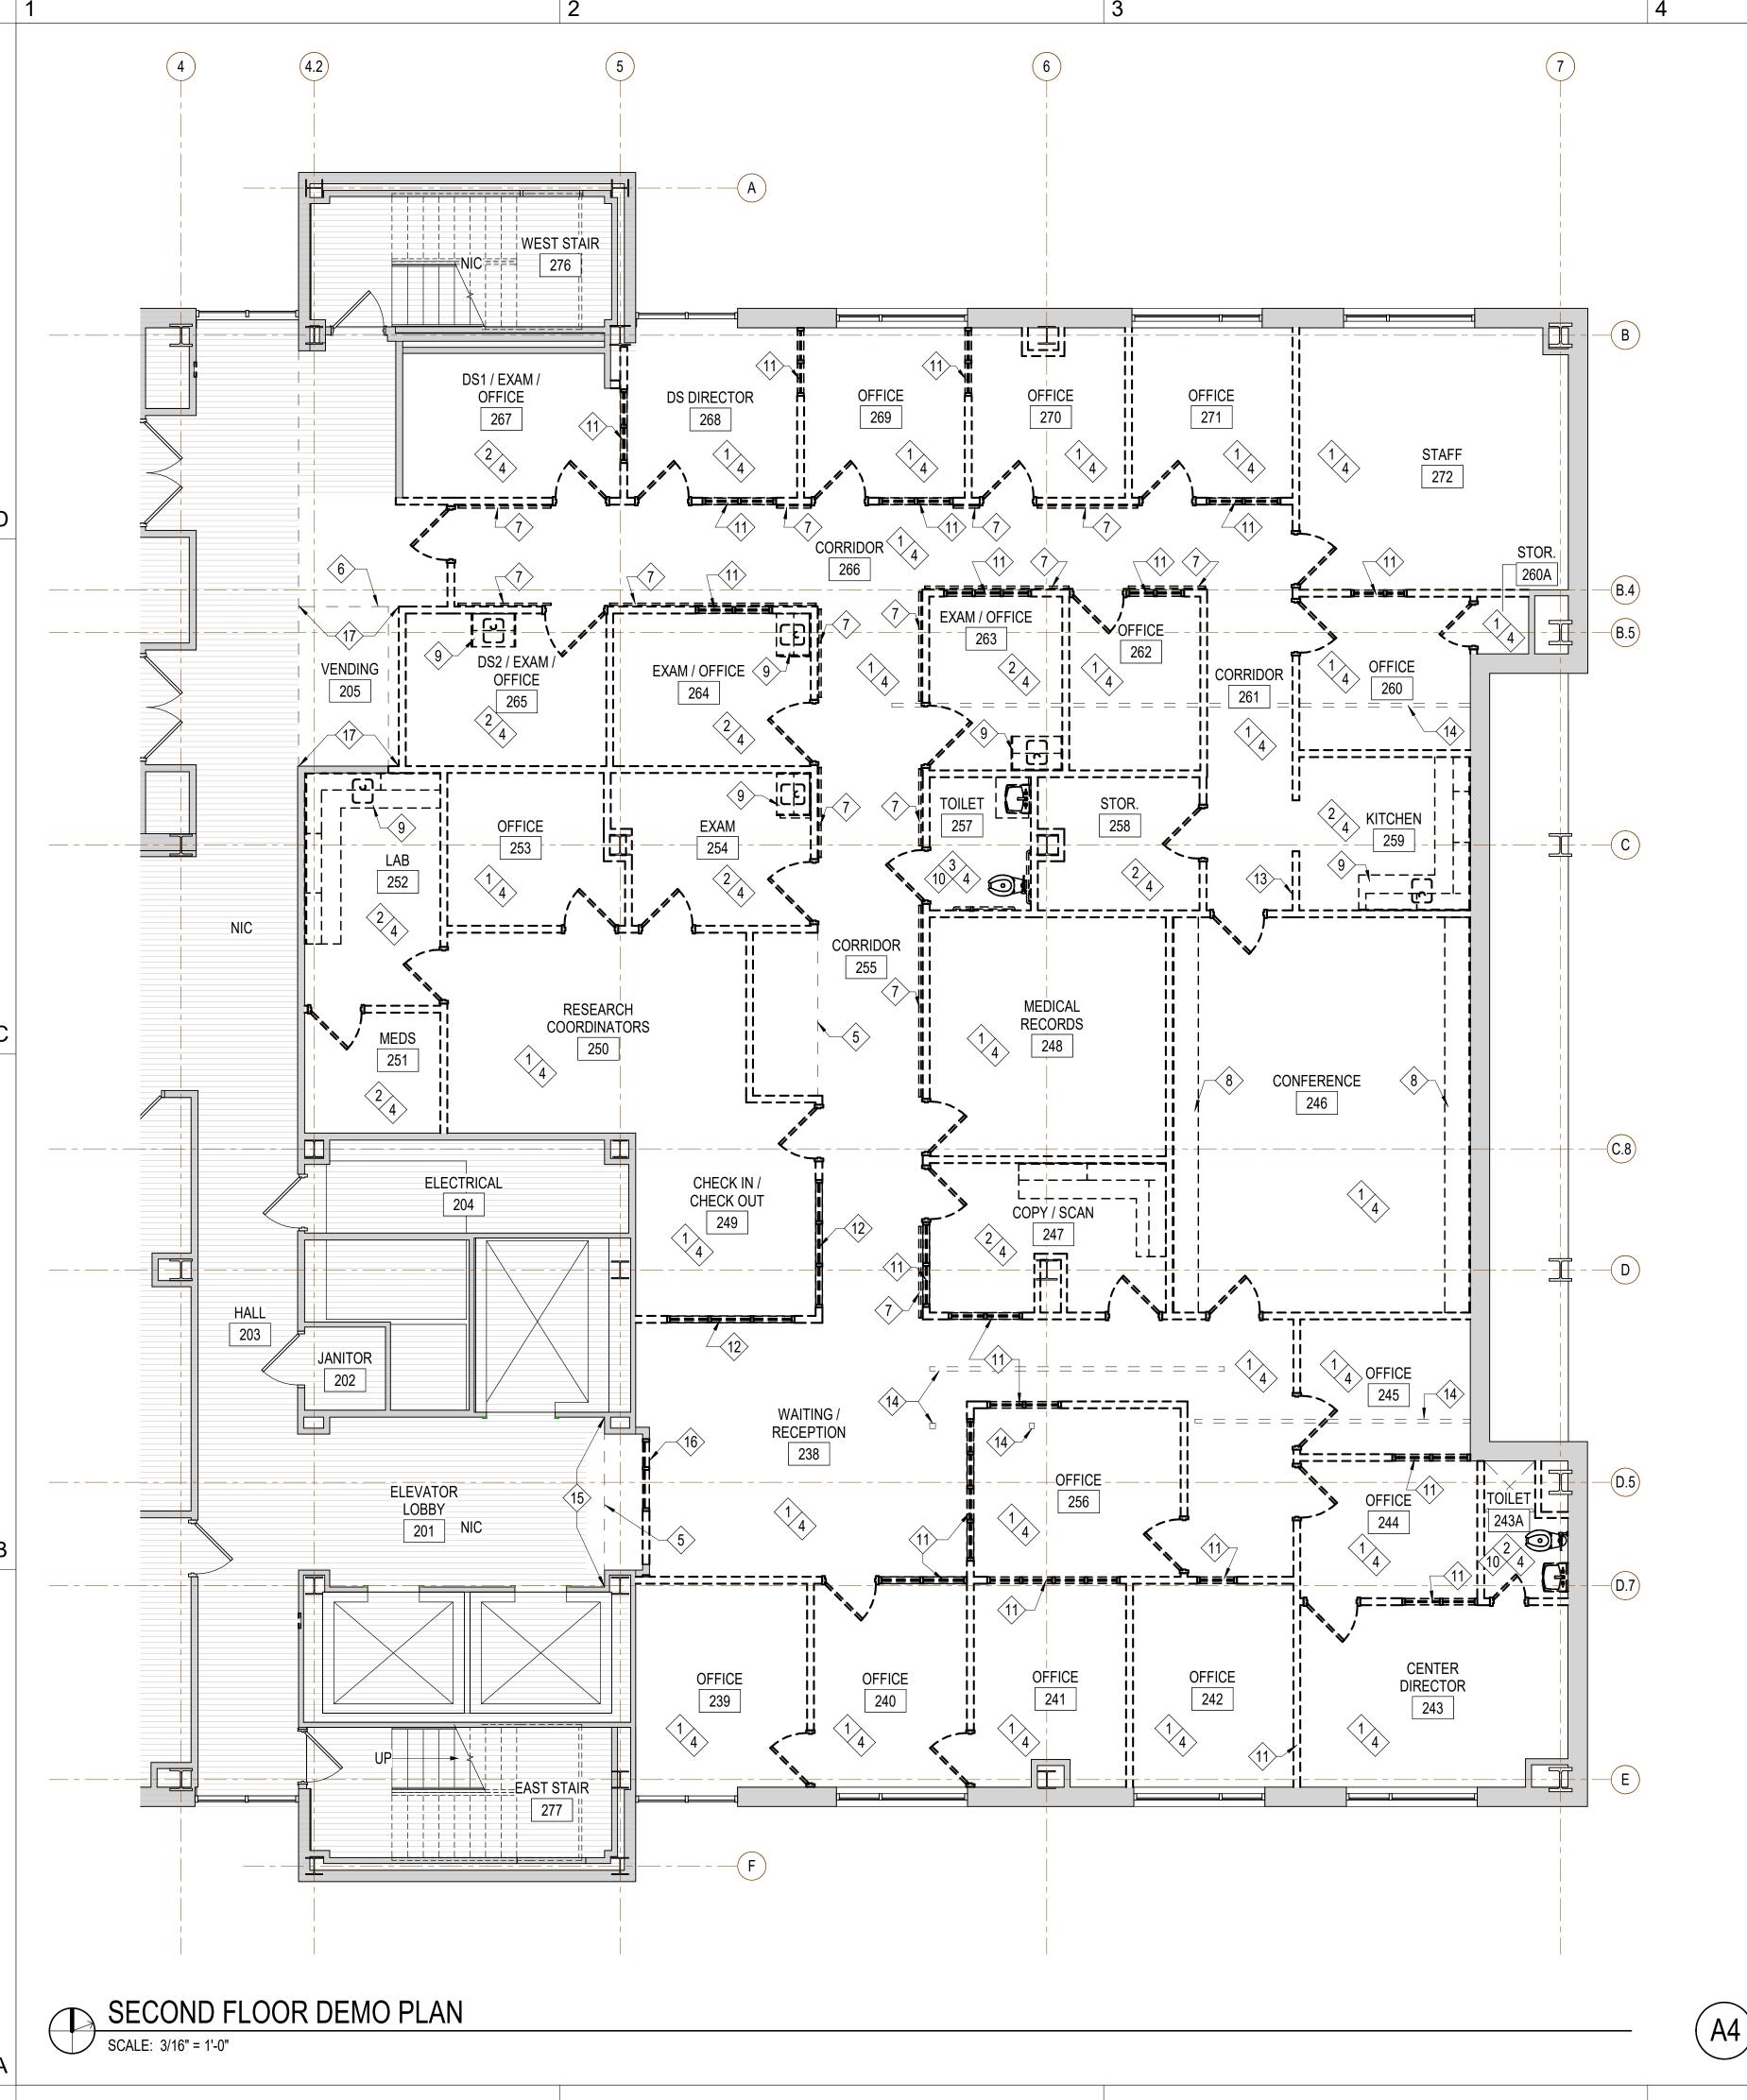


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DRAWN: TSM REVIEW: DLS

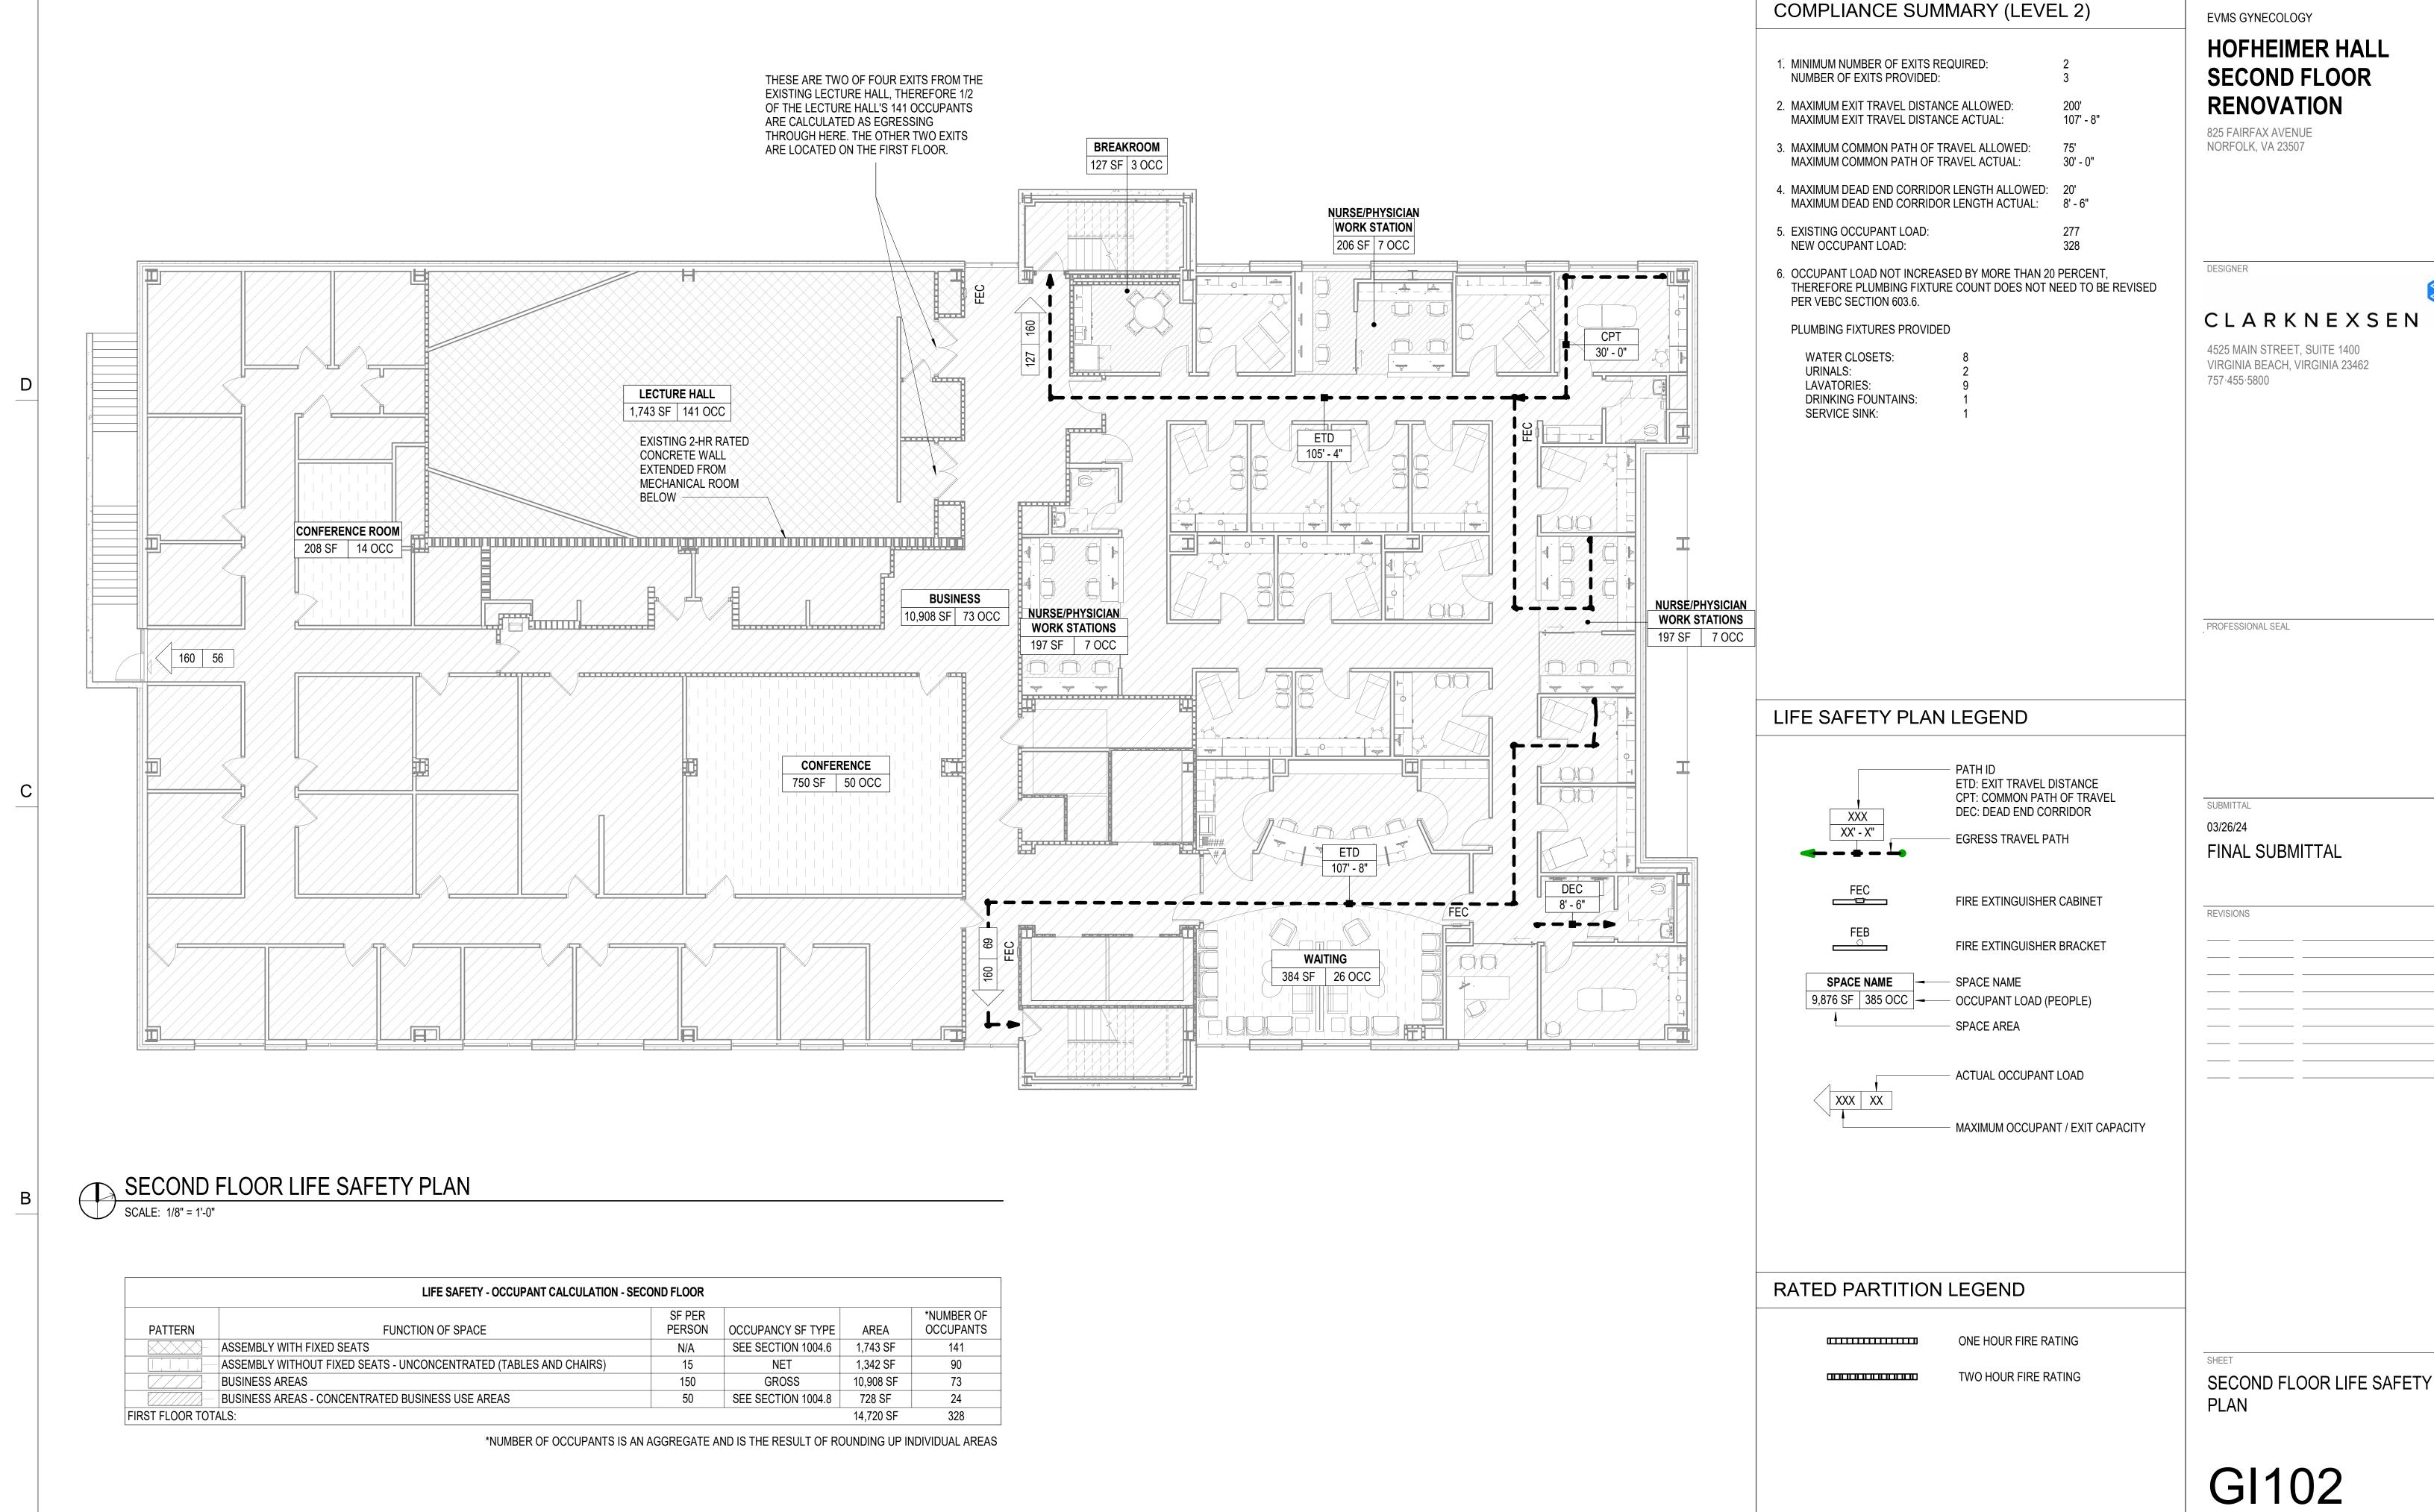
GRAPHIC SCALE(S)





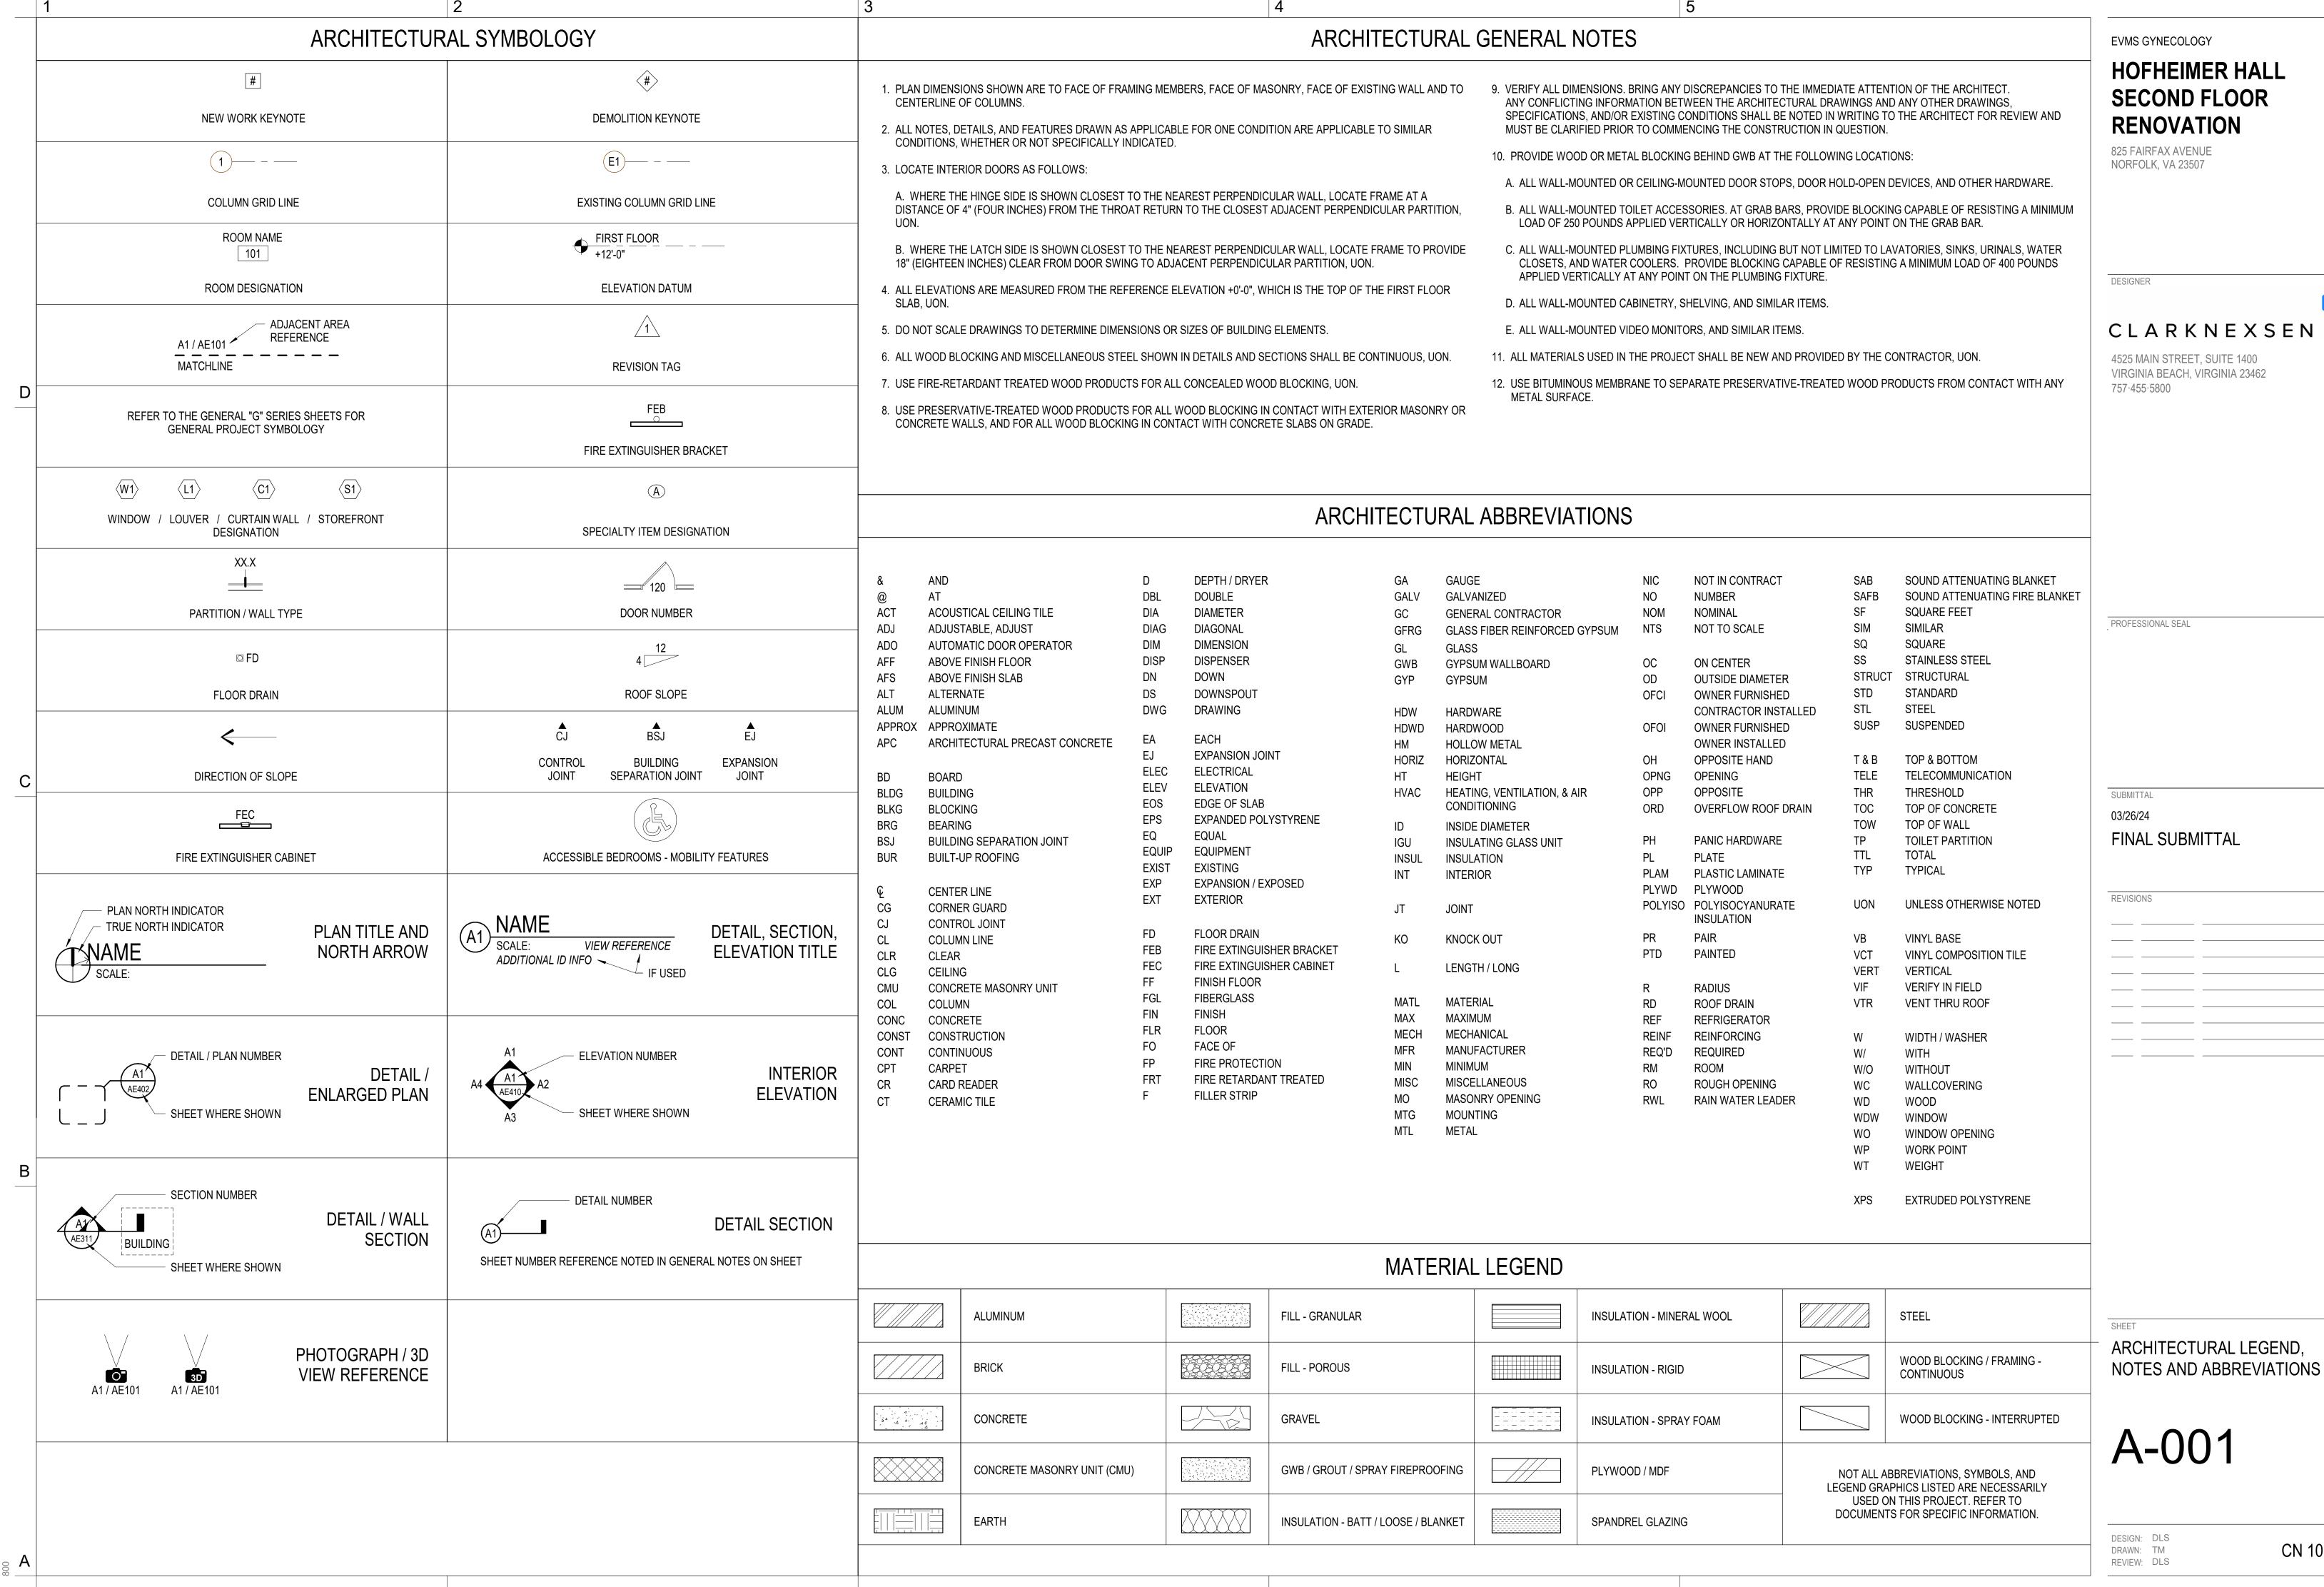



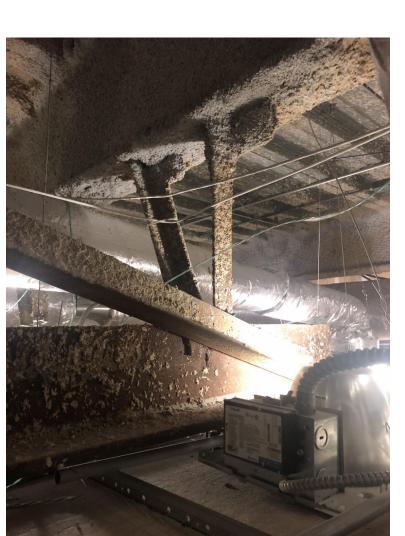

TYP EQUIPMENT SUPPORT NOT TO SCALE

GENERAL NOTES

- A. FIRE RATINGS ON EXISTING PARTITIONS NOT SHOWN FOR CLARITY. SEE LIFE SAFETY PLANS FOR LOCATIONS OF RATED CONSTRUCTION.
- B. EXTERIOR WALLS AND WINDOWS ARE TO REMAIN EXCEPT AS MODIFIED WITHIN THE CONTRACT DRAWINGS. EXISTING STRUCTURAL ELEMENTS (COLUMNS, BEAMS, FLOOR, ETC.) AND THE FIREPROOFING ON THESE ELEMENTS ARE TO REMAIN. SEE FIRE PROTECTION, PLUMBING, MECHANICAL, AND ELECTRICAL DEMOLITION PLANS FOR ADDITIONAL REQUIREMENTS ON THE REMOVAL, TERMINATION/CAPPING OF BUILDING SYSTEMS.
- C. REMOVE GYPSUM WALL BOARD ON EXISTING INTERIOR PARTITIONS TO REMAIN AND ON THE INSIDE FACE OF EXTERIOR WALLS AS REQUIRED TO REMOVE, ROUTE, AND INSTALL NEW BUILDING SYSTEM ELEMENTS AND BLOCKING INDICATED IN THESE CONTRACT DOCUMENTS.
- D. WORK IN NIC AREAS AND ON FLOOR BELOW: WORK ABOVE THE CEILING ON THE FLOOR BELOW AND IN AREAS DENOTED NIC WILL BE REQUIRED TO PERFORM THE ENGINEERING SYSTEMS WORK SHOWN ELSEWHERE IN THE CONTRACT DOCUMENTS. WHERE REQUIRED, REMOVE, STORE, AND REINSTALL CEILING TILES TO EXTENTS REQUIRED TO PERFORM WORK.

DEMOLITION KEY NOTES

- REMOVE CARPET FLOORING, ADHESIVE AND VINYL BASE, ENTIRE ROOM UNLESS OTHER LIMITS SHOWN.
- 2 REMOVE VCT FLOORING AND VINYL WALL BASE, ENTIRE ROOM UNLESS OTHER LIMITS SHOWN.
- REMOVE CERAMIC TILE FLOORING AND CERAMIC WALL TILE, ENTIRE ROOM UNLESS OTHER LIMITS SHOWN.
- REMOVE ACOUSTICAL CEILING TILES AND GRID, ENTIRE ROOM UNLESS OTHER LIMITS SHOWN.
- 5 REMOVE GWB BULKHEAD.
- 6 REMOVE GWB CEILING TO EXTENT NEEDED FOR DEMO AND INSTALLING NEW WORK, REPLACE DAMAGED GWB & WALL BASE, PATCH GWB & WALL BASE TO MATCH EXISTING.
- 7 REMOVE WALL-MOUNTED BUMPER RAIL / HANDRAIL.
- 8 REMOVE CASEWORK.
- 9 REMOVE CASEWORK, COUNTER AND SINK.
- 10 REMOVE ALL BATHROOM ACCESSORIES.
- 11 REMOVE INTERIOR HOLLOW METAL FRAME AND GLASS.
- 12 REMOVE INTERIOR SLIDING GLASS PANELS.
- 13 REMOVE RECESSED FIRE EXTINGUISHER CABINET.
- 14 REMOVE ABANDONED ABOVE-CEILING STEEL EQUIPMENT SUPPORTS. SEE A4/AD101 FOR TYPICAL PHOTO EXAMPLES.
- 15 CUT WALLCOVERING AT INSIDE CORNER AND REMOVE BETWEEN THESE
- 16 REMOVE HOLLOW METAL DOOR, FRAME, AND SIDELIGHTS. REMOVE WOOD WALL PANELING BENEATH THE SIDELIGHT.
- 17 REMOVE VCT FLOORING, WALL BASE, AND ADHESIVE TO EXTENTS

RATED PARTITION LEGEND

EXISTING WALL TO REMAIN

EXISTING WALL TO BE REMOVED IN ITS ENTIRETY X' - Y" PORTION OF EXISTING WALL TO BE DEMOLISHED TO * *

RECEIVE NEW WORK (REFER TO NEW FLOOR PLANS) EXISTING DOOR TO REMAIN

EXISTING DOOR AND HARDWARE TO BE REMOVED.

FRAME TO REMAIN IN PLACE. REFER TO NEW WORK FLOOR PLANS FOR DOOR TAGS. EXISTING WALL, DOOR, FRAME AND HARDWARE TO

BE REMOVED IN THEIR ENTIRETY EXISTING OVERHEAD ITEM TO BE REMOVED, UNLESS

OTHERWISE NOTED EXISTING PLUMBING FIXTURES TO BE REMOVED

AREA NOT IN CONTRACT (NIC)

GRAPHIC SCALE(S)

EVMS GYNECOLOGY

HOFHEIMER HALL **SECOND FLOOR RENOVATION**

825 FAIRFAX AVENUE NORFOLK, VA 23507

DESIGNER

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PROFESSIONAL SEAL

SUBMITTAL

03/26/24 FINAL SUBMITTAL

SECOND FLOOR DEMOLITION

AD101

DESIGN: DLS DRAWN: TSM

REVIEW: DLS

PLAN

ROOM SCHEDULE NO. **ELEVATOR LOBBY** JANITOR HALL ELECTRICAL VENDING WAITING PRACTICE MANAGER URODYNAMICS TOILET 242 CYSTOSCOPY UROGYN EXAM CORRIDOR PHYSICIAN NURSE 247 UROGYN EXAM TOILET PROCEDURE ULTRASOUND 251 NURSE 252 PHYSICIAN 253 ULTRASOUND 254 BREAKROOM 255 CORRIDOR 256 STORAGE 257 TOILET 258 MIGS EXAM 259 MIGS EXAM MIGS EXAM MIGS EXAM UROGYN EXAM 263 GYN EXAM 264 GYN EXAM 265 CORRIDOR NURSE 267 PHYSICIAN CORRIDOR GYN EXAM GYN EXAM UROGYN EXAM 272 SUPPLY

RECEPTION

WEST STAIR

EAST STAIR

SUPPLY

273

274

GENERAL NOTES

KEY NOTES

CONSTRUCTION.

- A. FIRE RATINGS ON EXISTING PARTITIONS NOT SHOWN FOR CLARITY. SEE LIFE SAFETY PLANS FOR LOCATIONS OF FIRE RATED CONSTRUCTION.
- B. PATCH HOLES IN FLOOR SLAB EXISTING AS A RESULT OF DEMOLITION AND NEW WORK INDICATED IN THE CONSTRUCTION DOCUMENTS. SEE FIRE PROTECTION, PLUMBING, MECHANICAL, AND ELECTRICAL DRAWINGS FOR
- C. PATCH HOLES IN EXISTING PARTITIONS NOT OTHERWISE COVERED UP BY NEW CONSTRUCTION AS A RESULT OF DEMOLITION AND NEW WORK INDICATED IN THE CONSTRUCTION DOCUMENTS. PATCH TO MATCH EXISTING ADJACENT CONSTRUCTION.
- D. PATCH GYPSUM WALL BOARD WHERE REMOVED ON EXISTING PARTITIONS AND EXTERIOR WALLS TO INSTALL NEW BUILDING SYSTEM ELEMENTS AND BLOCKING.

1 PATCH / INFILL PARTITION TO MATCH EXISTING ADJACENT

3 PROVIDE 3 FORM SIMPLE SPEC 200.29 WITH DECORATIVE RESIN PANEL

(DRP2) 48" H X 120" L PONY WALL. ANCHOR TO FLOOR PER

4 DECORATIVE RESIN PANEL (DRP1) WITH 3 FORM VERSA POST AND

5 INSTALL BLOCKING IN WALL; 3'-0" AFF TO 7'-0" AFF X 8'-0" WIDE,

2 RECESSED FIRE EXTINGUISHER CABINET.

CLAMP PARTITION HARDWARE.

CENTERED ON WALL.

MANUFACTURER'S WRITTEN INSTRUCTIONS.

DESIGNER

EVMS GYNECOLOGY

HOFHEIMER HALL

SECOND FLOOR

RENOVATION

825 FAIRFAX AVENUE

NORFOLK, VA 23507

CLARKNEXSEN

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PROFESSIONAL SEAL

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RATED PARTITION LEGEND

ONE HOUR FIRE RATING

TWO HOUR FIRE RATING

SECOND FLOOR FLOOR PLAN

AE101

GRAPHIC SCALE(S)

DESIGN: DLS

DRAWN: TSM REVIEW: DLS

SECOND FLOOR PLAN



GENERAL NOTES

1: FIRE RATINGS ON EXISTING PARTITIONS NOT SHOWN FOR CLARITY. SEE LIFE SAFETY PLANS FOR LOCATIONS OF RATED CONSTRUCTION.

2. CEILINGS IN AREAS NOT IN CONTRACT NOT SHOWN FOR CLARITY.

KEY NOTES

1 PATCH / INFILL PARTITION TO MATCH EXISTING ADJACENT CONSTRUCTION.

2 RECESSED FIRE EXTINGUISHER CABINET.

3 GWB SOFFIT; SEE DETAIL A4/AE502.

4 LINEAR WOOD SLAT CEILING. CENTER CEILING ON SPACE BETWEEN SLATS; 3/4" GAP FROM GWB AT ALL EDGES.

5 CUBICLE CURTAIN AND TRACK.

INDICATES BRACKET, WALL

MOUNTED ITEM

 \boxtimes

SUPPLY GRILLE

O [

LIGHT FIXTURES

CEILING MOUNTED

EXIT LIGHT

OS

CEILING MOUNTED

OCCUPANCY SENSOR

8'-0"

CEILING HEIGHT

0 0

V

FIRE ALARM

STROBE

DETECTOR

 F

FIRE ALARM

HORN STROBE

P

PHOTO

DETECTOR

6 PATCH GWB CEILING TO MATCH EXISTING ADJACENT CONSTRUCTION AND HEIGHT.

REFLECTED CEILING PLAN LEGEND

SPRINKLER HEAD

RETURN GRILLE

EMERGENCY EGRESS LIGHT FIXTURES

CEILING MOUNTED

EXIT LIGHT W/ ARROW

EXHAUST FAN

EXP

EXPOSED CEILING

CEILING / SOFFIT

GWB

S

SPEAKER

CO

CARBON MONOXIDE

DETECTOR

 \square

SPEAKER W/

STROBE

S

SMOKE

DETECTOR

HOFHEIMER HALL **SECOND FLOOR RENOVATION**

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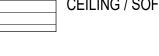
SUBMITTAL 03/26/24

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REVISIONS

WOOD TILE LAY-IN CEILING CEILING / SOFFIT

METAL PANEL CEILING / SOFFIT



RATED PARTITION LEGEND

4' x 4' ACOUSTICAL TILE LAY-IN CEILING

2' x 2' ACOUSTICAL

2' x 4' ACOUSTICAL

TILE LAY-IN CEILING

TWO HOUR FIRE RATING

ONE HOUR FIRE RATING


GRAPHIC SCALE(S)

CEILING PLAN

SECOND FLOOR REFLECTED

AE111

DESIGN: DLS DRAWN: TSM REVIEW: DLS

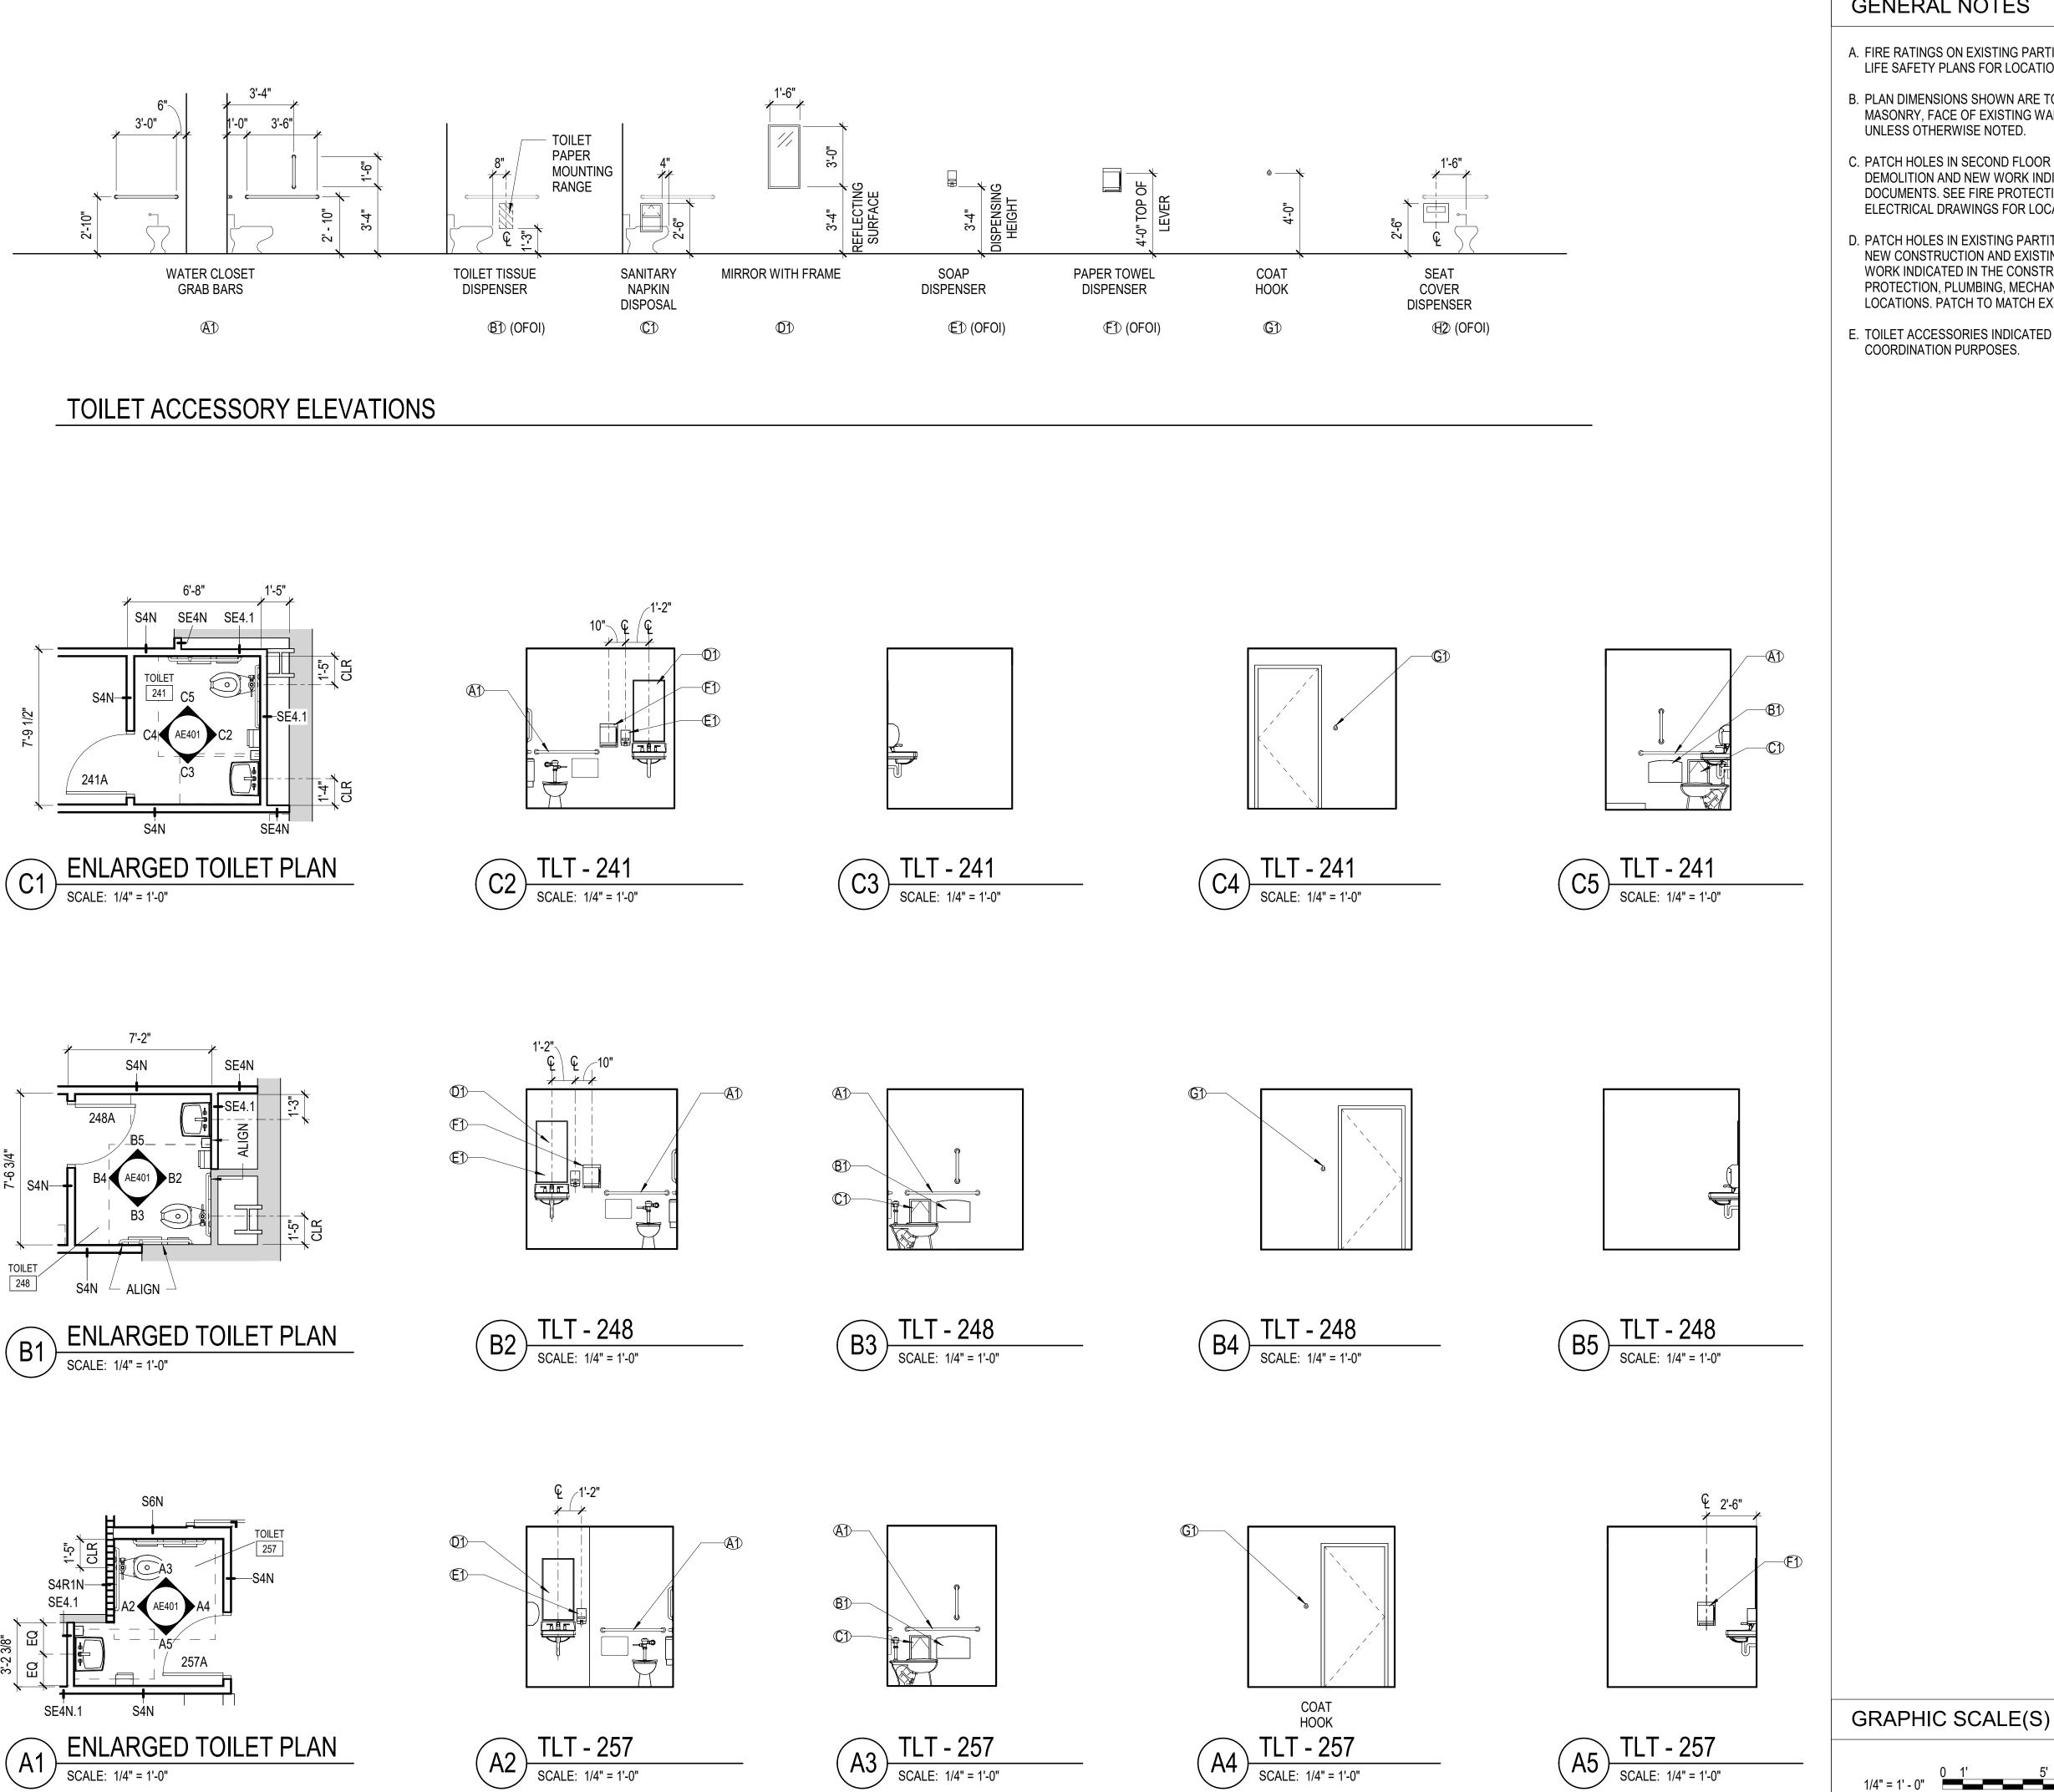

GENERAL NOTES

A. FIRE RATINGS ON EXISTING PARTITIONS NOT SHOWN FOR CLARITY. SEE LIFE SAFETY PLANS FOR LOCATIONS OF RATED CONSTRUCTION.

B. PLAN DIMENSIONS SHOWN ARE TO FACE OF FRAMING MEMBERS, FACE OF MASONRY, FACE OF EXISTING WALL AND TO CENTERLINE OF COLUMNS, UNLESS OTHERWISE NOTED.

C. PATCH HOLES IN SECOND FLOOR SLAB EXISTING AS A RESULT OF DEMOLITION AND NEW WORK INDICATED IN THE CONSTRUCTION DOCUMENTS. SEE FIRE PROTECTION, PLUMBING, MECHANICAL, AND ELECTRICAL DRAWINGS FOR LOCATIONS.

D. PATCH HOLES IN EXISTING PARTITIONS NOT OTHERWISE COVERED UP BY NEW CONSTRUCTION AND EXISTING AS A RESULT OF DEMOLITION AND NEW WORK INDICATED IN THE CONSTRUCTION DOCUMENTS. SEE FIRE PROTECTION, PLUMBING, MECHANICAL, AND ELECTRICAL DRAWINGS FOR LOCATIONS. PATCH TO MATCH EXISTING ADJACENT CONSTRUCTION.

E. TOILET ACCESSORIES INDICATED TO BE OFOI ARE SHOWN FOR COORDINATION PURPOSES.

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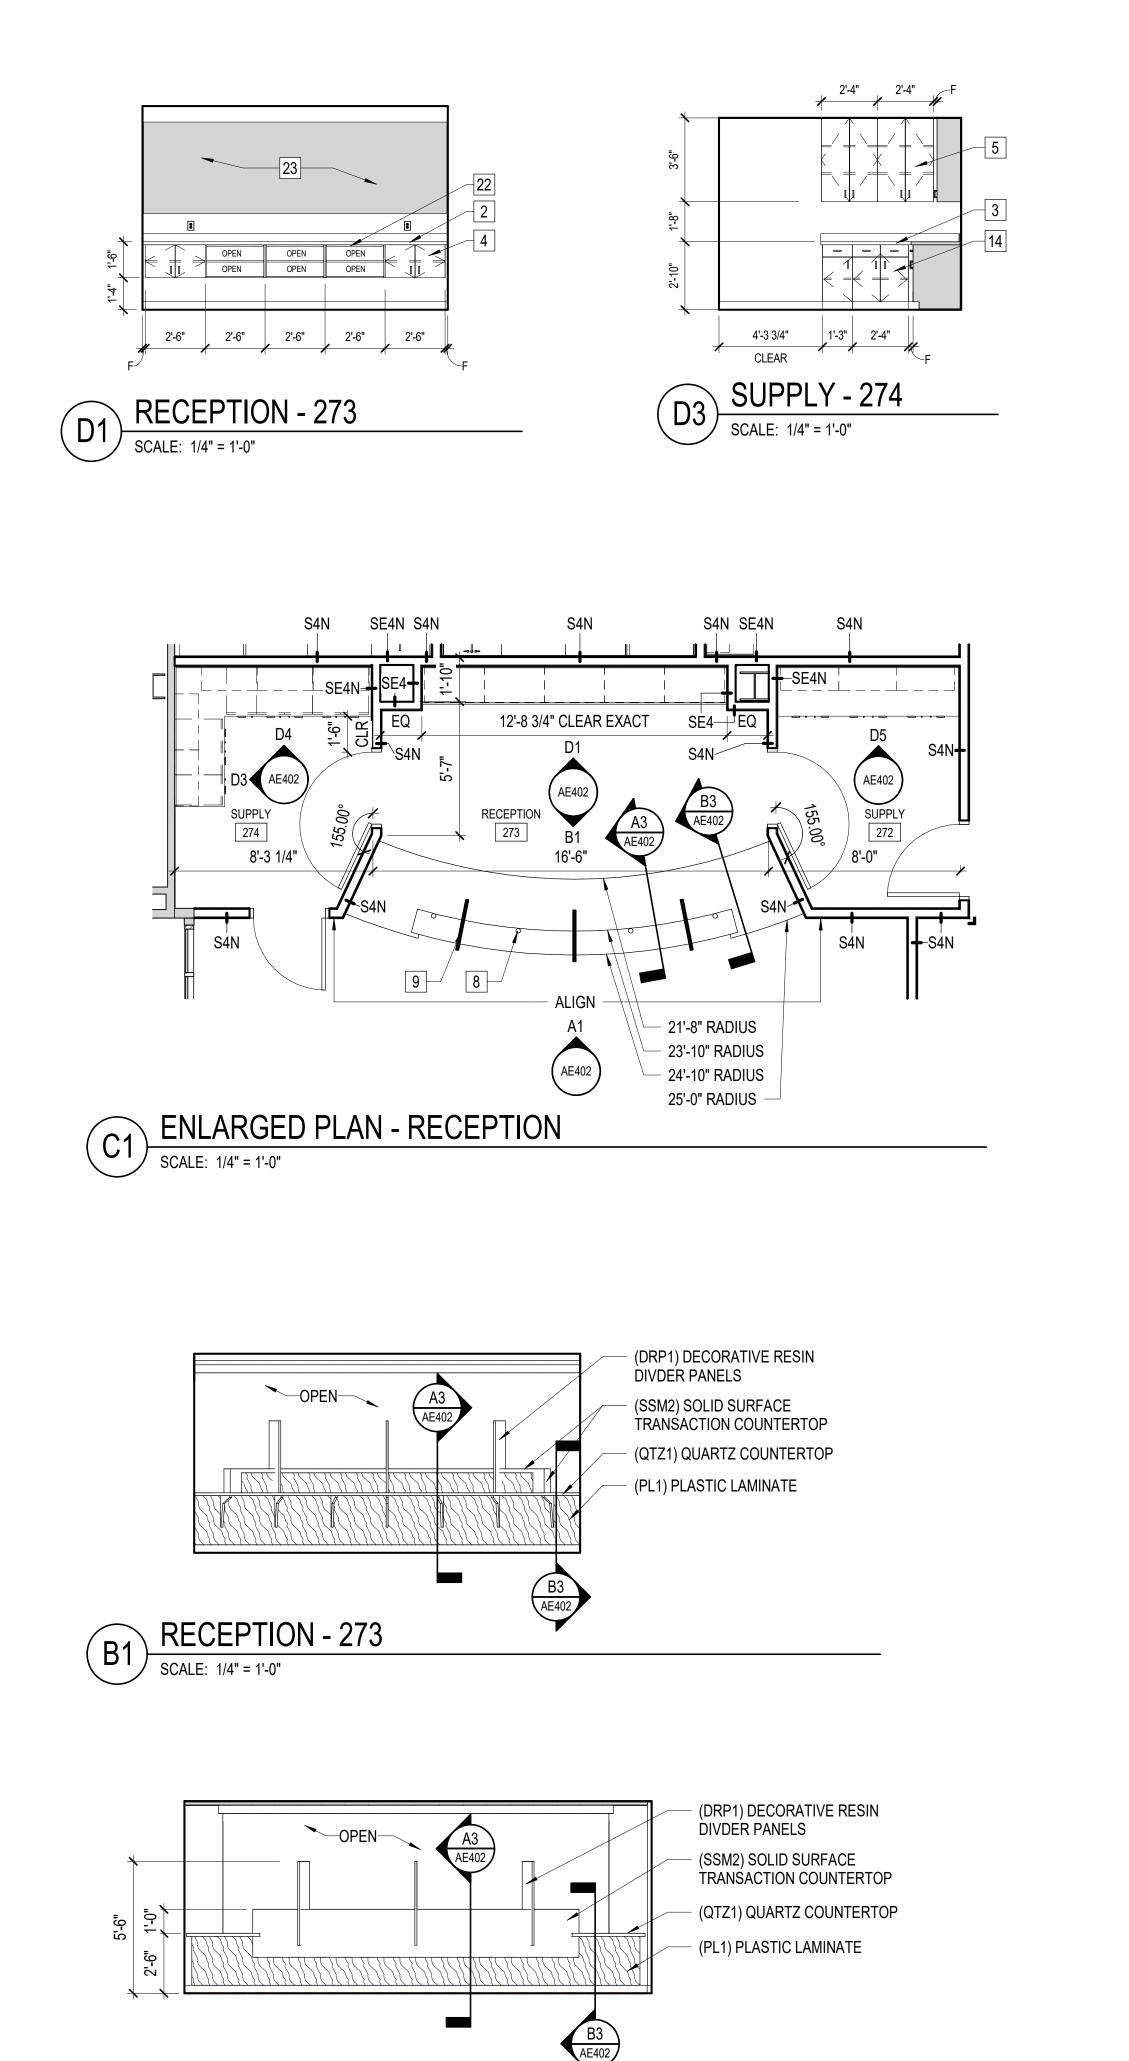
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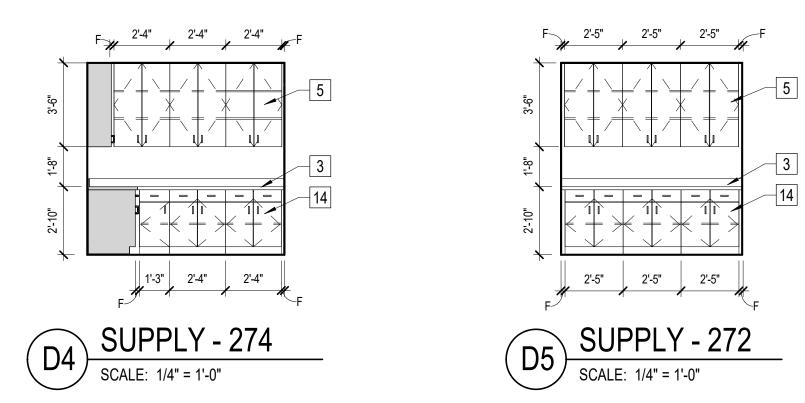
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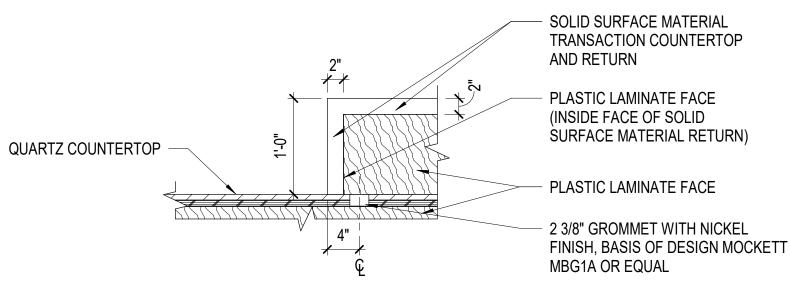
TOILET ROOM PLANS AND **ELEVATIONS**

AE401

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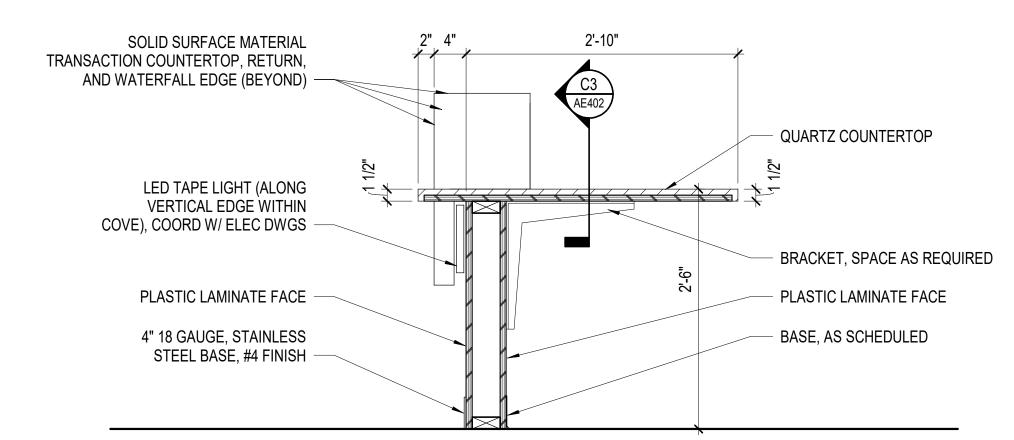







RECEPTION DESK DETAIL

SCALE: 1" = 1'-0"



RECEPTION DESK DETAIL

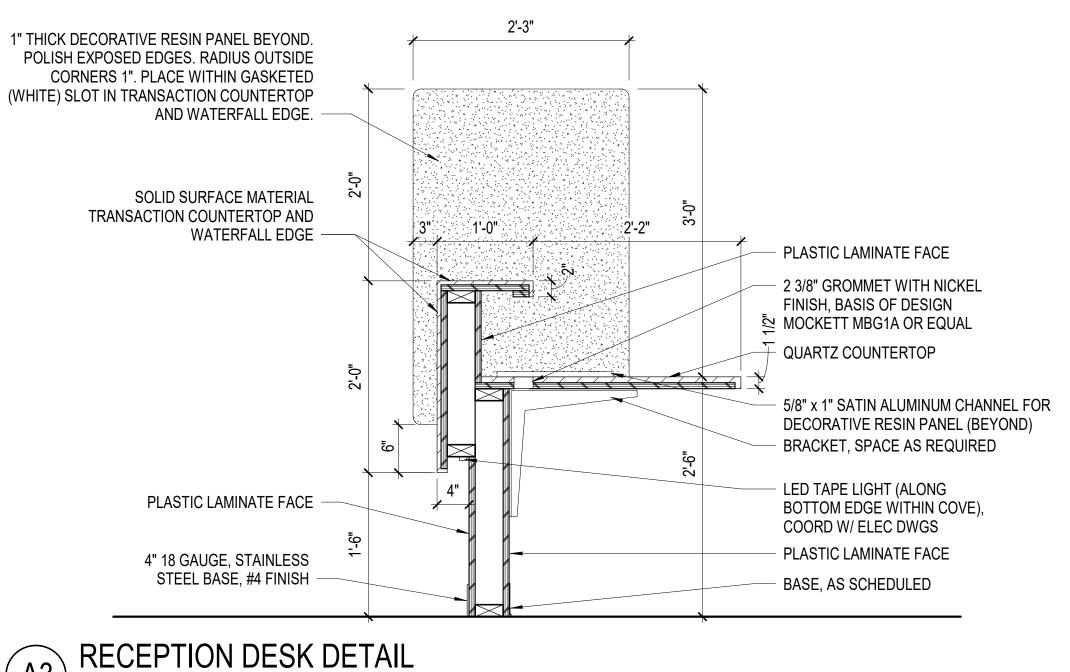

GENERAL NOTES

- A: PROVIDE FINISHED END PANELS FOR ALL WALL AND BASE CABINETS WITH EXPOSED SIDES.
- B. PROVIDE FILLER STRIPS TO MATCH ADJACENT CABINET FINISH WHERE "F" IS INDICATED IN DIMENSION STRINGS ON ELEVATIONS.

EVMS GYNECOLOGY

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GRAPHIC SCALE(S)

KEY NOTES

- 2 19" DEEP QUARTZ COUNTERTOP WITH SPLASHES
- 3 25" DEEP SOLID SURFACE COUNTERTOP WITH BACKSPLASH. PROVIDE SIDE SPLASHES WHERE ABUTTING AN ADJACENT WALL.
- 4 18" DEEP PLASTIC LAMINATE WALL CABINET WITH ADJUSTABLE SHELF.
- 5 12" DEEP PLASTIC LAMINATE WALL CABINET WITH ADJUSTABLE SHELVES.
- 8 2 3/8" GROMMET WITH NICKEL FINISH, BASIS OF DESIGN MOCKETT MBG1A OR EQUAL
- 9 DECORATIVE RESIN PANEL (DRP1), SPACE EQUALLY FOR 4 WORKSPACES OF THE SAME WIDTH
- 14 24" DEEP PLASTIC LAMINATE BASE CABINET WITH DRAWERS AND ADJUSTABLE SHELF.
- 22 18" DEEP PLASTIC LAMINATE WALL CABINET WITH OPEN SHELVES.
- 23 INSTALL BLOCKING FROM 4'-0" AFF TO 8'-0" AFF FOR FUTURE SIGNAGE/ SHELVING.

PROFESSIONAL SEAL

SUBMITTAL

03/26/24 FINAL SUBMITTAL

REVISIONS


ENLARGED PLANS & INTERIOR ELEVATIONS


AE402

DESIGN: DLS DRAWN: TSM REVIEW: DLS

RECEPTION - 273

SCALE: 1/4" = 1'-0"

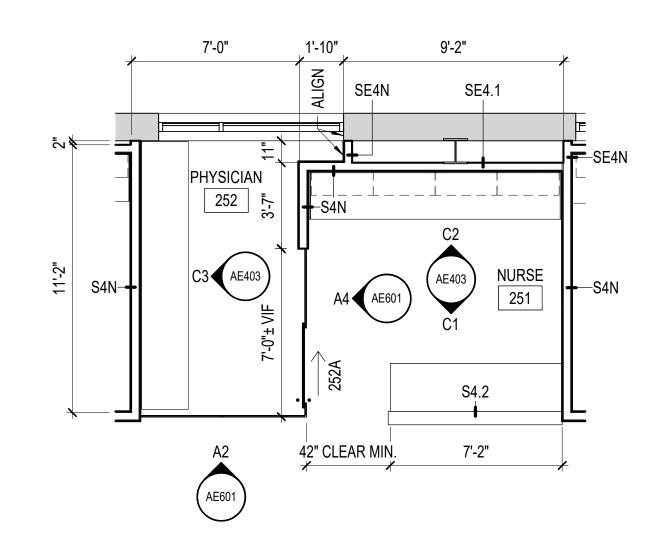

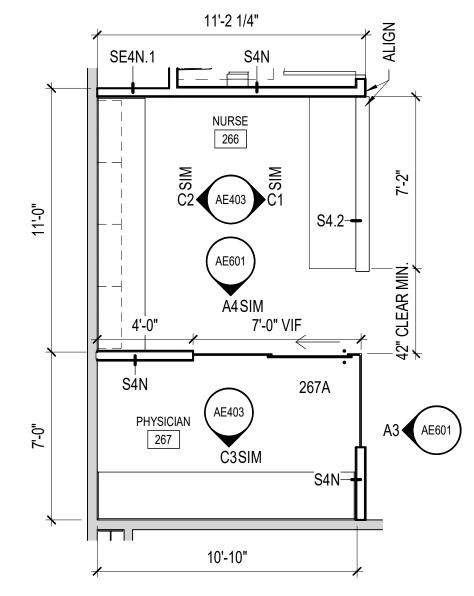


D2 ENLARGED PLAN

SCALE: 1/4" = 1'-0"

2


D3 ENLARGED PLAN


SCALE: 1/4" = 1'-0"

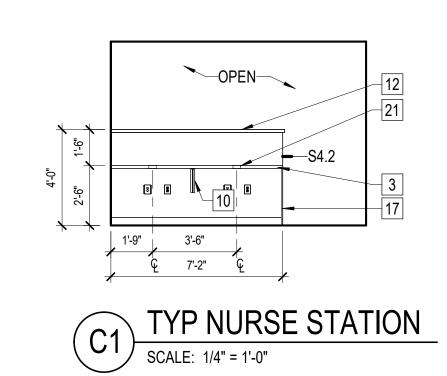

ENLARGED PLAN

SCALE: 1/4" = 1'-0"

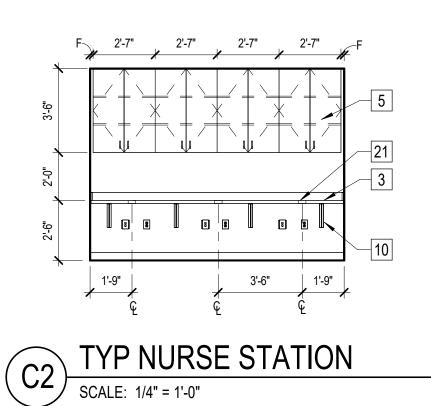

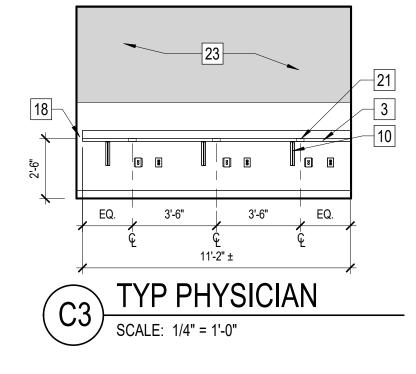

GENERAL NOTES

- A. PROVIDE FINISHED END PANELS FOR ALL WALL AND BASE CABINETS WITH EXPOSED SIDES.
- B. PROVIDE FILLER STRIPS TO MATCH ADJACENT CABINET FINISH WHERE "F" IS INDICATED IN DIMENSION STRINGS ON ELEVATIONS.

EVMS GYNECOLOGY

HOFHEIMER HALL SECOND FLOOR RENOVATION

825 FAIRFAX AVENUE NORFOLK, VA 23507

DESIGNER

CLARKNEXSEN

4525 MAIN STREET, SUITE 1400 VIRGINIA BEACH, VIRGINIA 23462 757·455·5800

KEY NOTES

- 3 25" DEEP SOLID SURFACE COUNTERTOP WITH BACKSPLASH. PROVIDE SIDE SPLASHES WHERE ABUTTING AN ADJACENT WALL.
- 5 12" DEEP PLASTIC LAMINATE WALL CABINET WITH ADJUSTABLE SHELVES.
- 10 COUNTERTOP SUPPORT BRACKET, SPACE AS REQUIRED. REFERENCE SHEET IF101 FOR PROPOSED SEATING ARRANGEMENT.
- 12 SOLID SURFACE TOP CAP, REFER TO PARTITION TERMINATION DETAIL ON A1/AE501.
- 17 PLASTIC LAMINATE END PANEL.
- 18 LEAVE 2" GAP WHERE COUNTER MEETS GLASS DEMOUNTABLE PARTITION. RUN COUNTER FULL WIDTH WHERE IT MEETS GYPSUM BOARD
- 21 2 3/8" GROMMET WITH NICKEL FINISH, BASIS OF DESIGN MOCKETT MBG1A OR EQUAL.
- 23 INSTALL BLOCKING FROM 4'-0" AFF TO 8'-0" AFF FOR FUTURE SIGNAGE/ SHELVING.

PROFESSIONAL SEAL

SUBMITTAL 03/26/24

FINAL SUBMITTAL

REVISIONS


OUEET

ENLARGED PLANS & INTERIOR ELEVATIONS

AE403

GRAPHIC SCALE(S)

4" = 1' - 0"

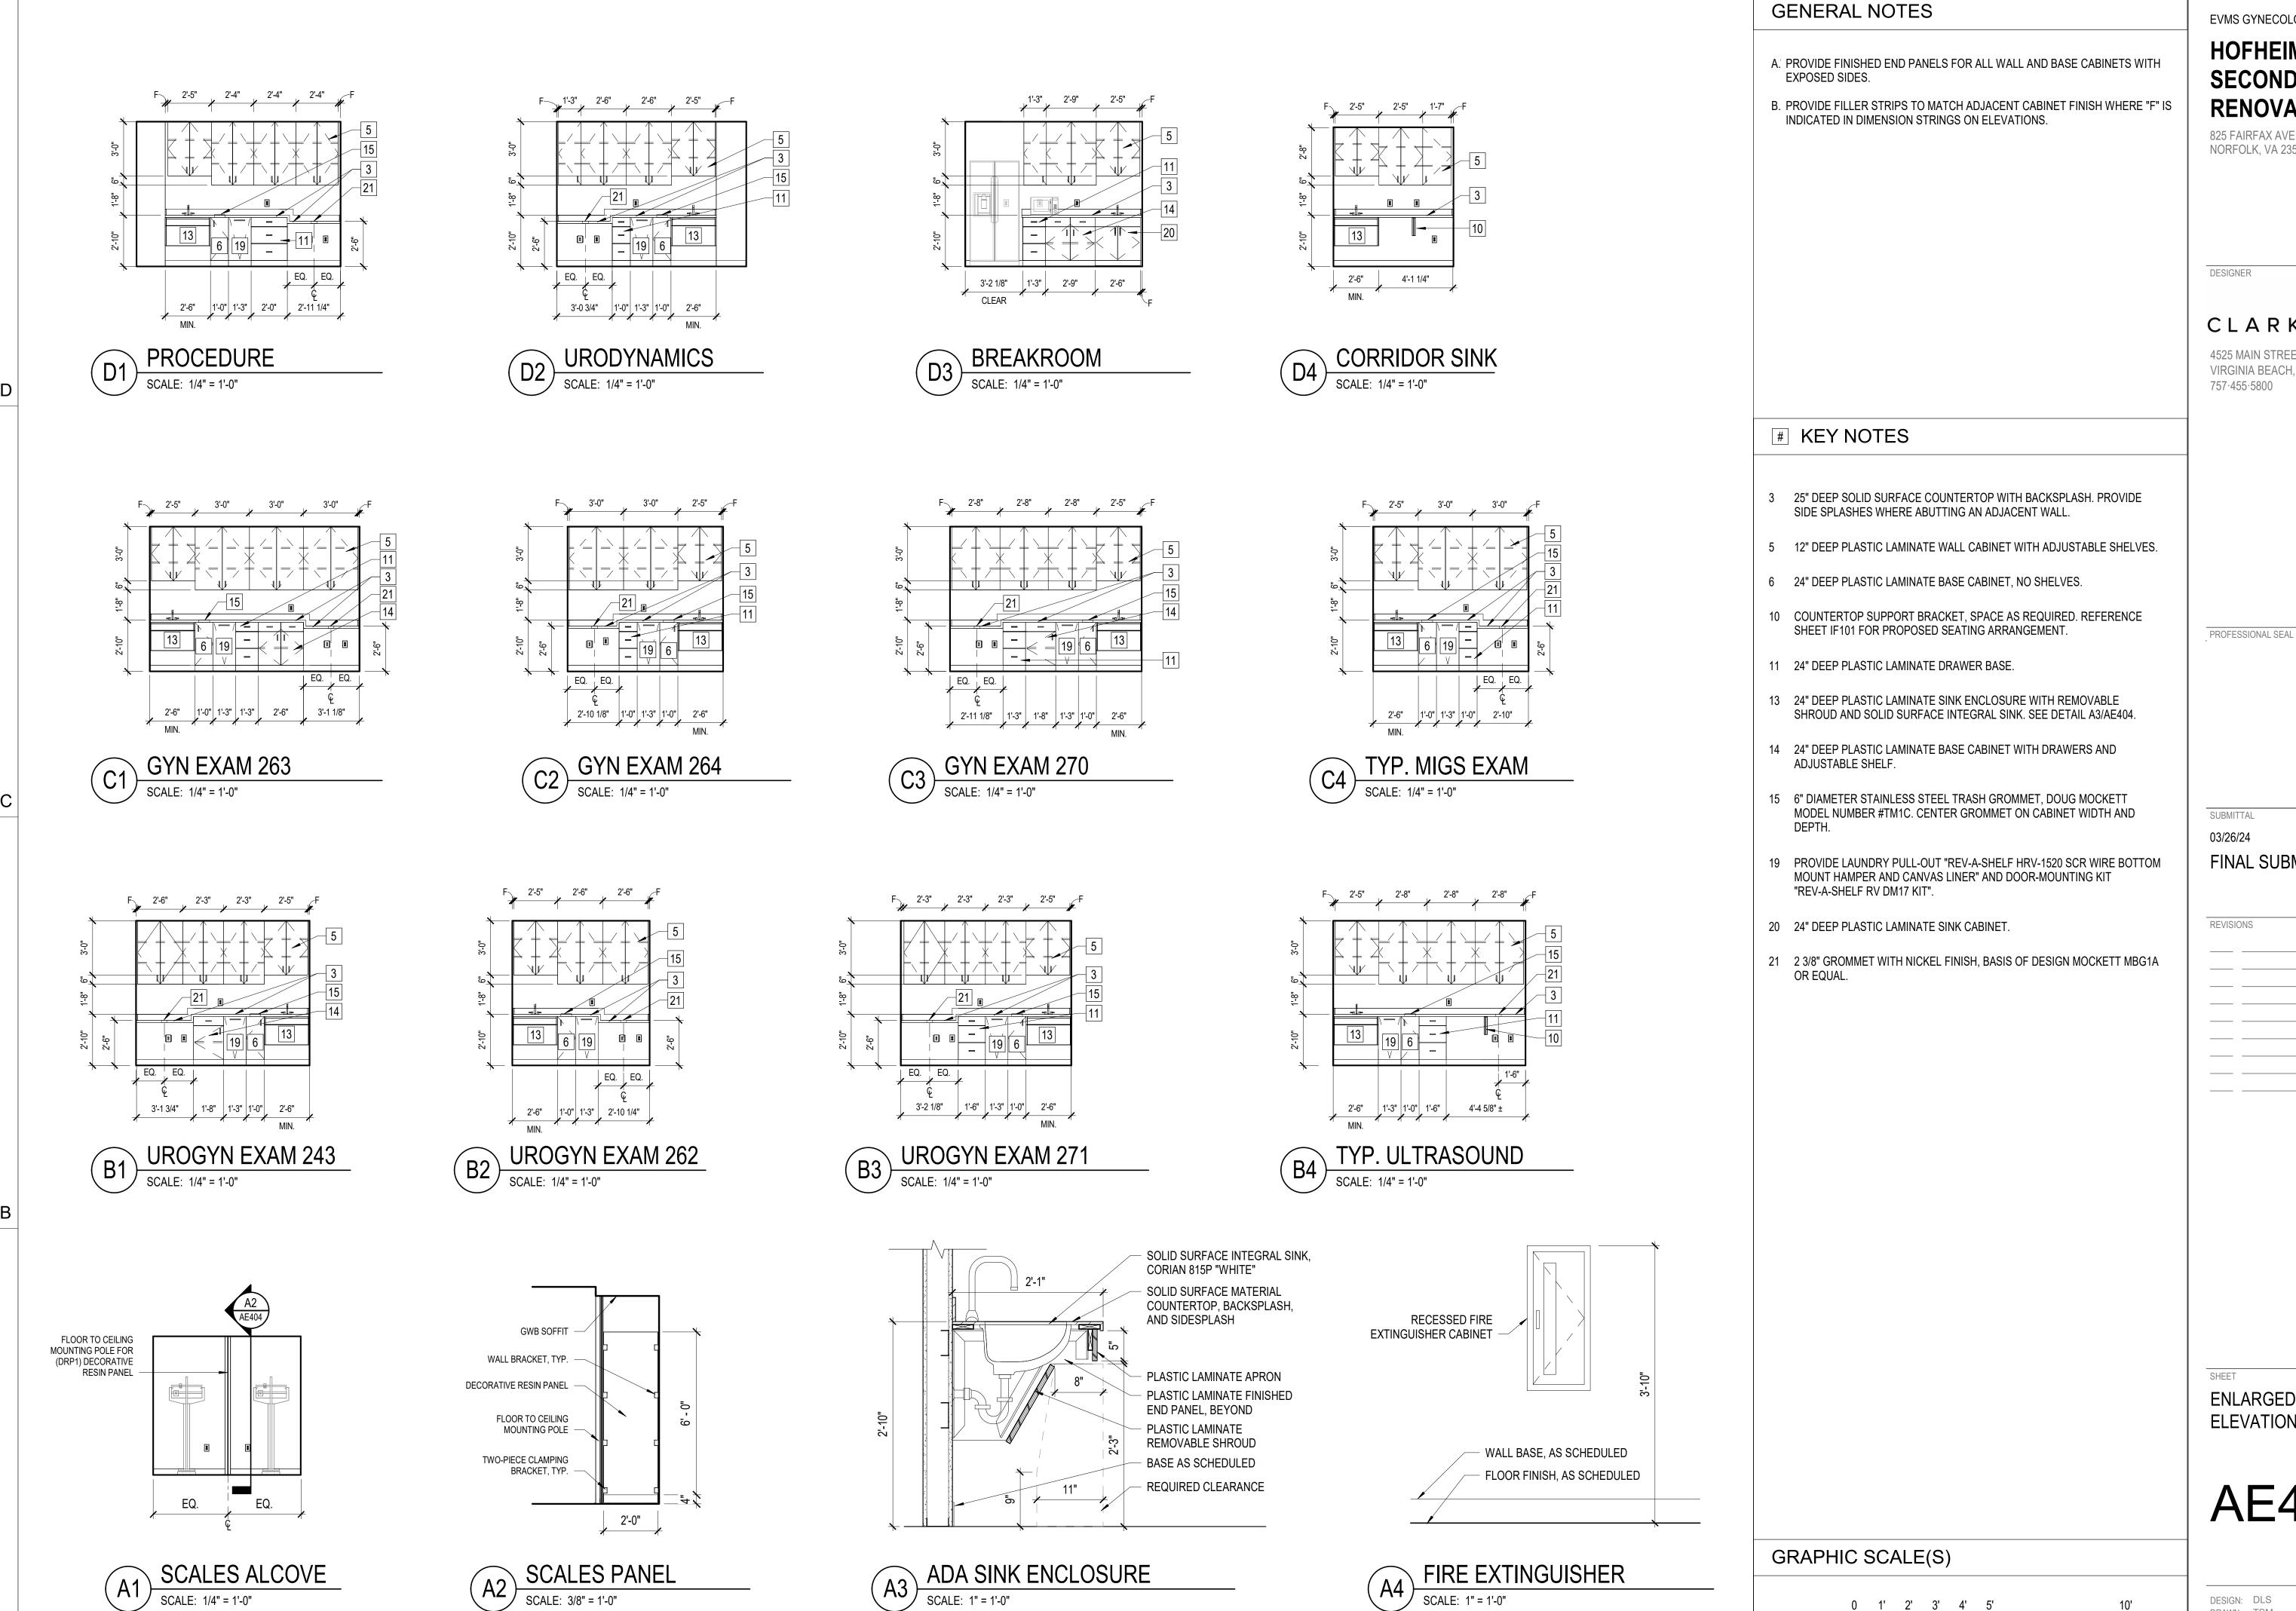

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4525 MAIN STREET, SUITE 1400 VIRGINIA BEACH, VIRGINIA 23462 757.455.5800

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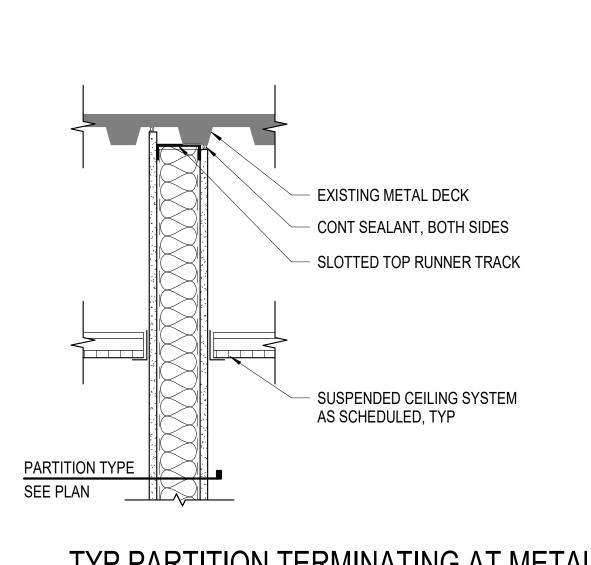
REVISIONS

ENLARGED PLANS & INTERIOR ELEVATIONS

AE404


DESIGN: DLS DRAWN: TSM

REVIEW: DLS




TYP PARTITION TERMINATING AT METAL **DECK ABOVE**


SCALE: 1 1/2" = 1'-0"

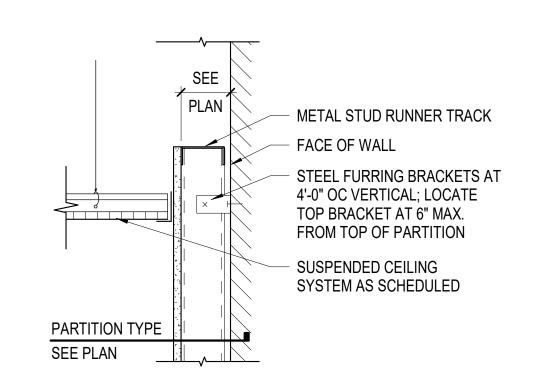

TYP FURRED WALL ABOVE CEILING

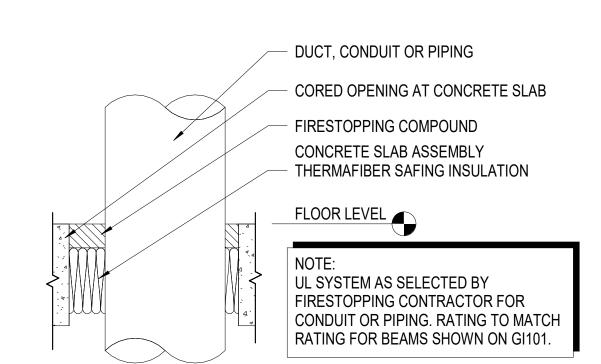

TYP PENETRATION AT FLOOR SCALE: 1 1/2" = 1'-0"

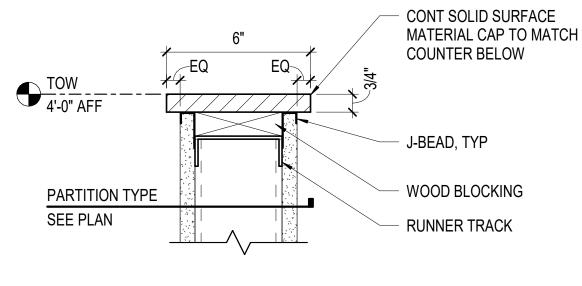


TERMINATION DETAIL

STUDS IN NON-RATED PARTITIONS MAY RUN EITHER TO THE UNDERSIDE OF RATED FLOOR-CEILING/FLOOR-ROOF ASSEMBLY ABOVE, OR THEY MAY BE DIAGONALLY BRACED AT 6" ABOVE CEILING. DIAGONALLY BRACED STUDS ARE NOT ALLOWED IN ROOMS WITH EXPOSED CEILINGS. 3 5/8" METAL STUD DIAGONAL CROSS MAXIMUM 4'-0" OC STAGGERED. EXTEND TO THE STRUCTURE ABOVE AND SECURED WITH METAL CLIP ANGLE **GWB CEILING** ACT CEILING AS SCHEDULED AS SCHEDULED SEALANT -CONT TOP TRACK

TYP PARTITION TERMINATING ABOVE


CEILING SCALE: 1 1/2" = 1'-0"

PARTITION TYPE

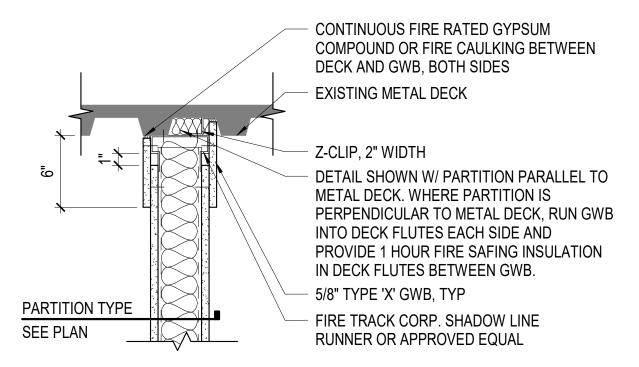

TYP FIRE RATED PARTITION TERMINATING AT METAL DECK ABOVE


SCALE: 1 1/2" = 1'-0"

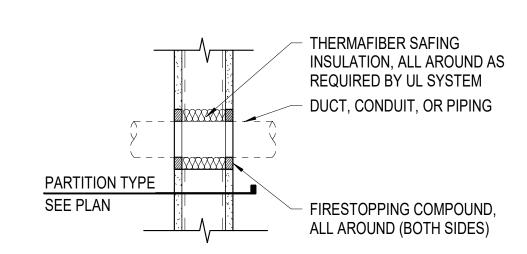

UL SYSTEM AS SELECTED BY FIRESTOPPING MANUFACTURER FOR UNINSULATED AND INSULATED DUCTS, CONDUIT OR PIPING. RATING TO MATCH PARTITION RATING (1 HOUR MIN.)

TYP PENETRTION THROUGH FIRE RATED

PARTITION SCALE: 1 1/2" = 1'-0"

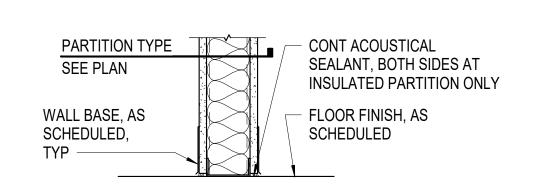

TYP BASE OF PARTITION DETAIL

6" STEEL STUDS @ 16" OC WITH ONE LAYER OF 5/8" GWB ON EACH SIDE. STEEL STUD PARTITION, INSULATED: S#N 3 5/8" STEEL STUDS @ 16" OC WITH ONE LAYER OF 5/8" GWB ON EACH SIDE AND 3 1/2" 3# MINERAL WOOL SOUND ATTENUATION BATT BETWEEN STUDS. 6" STEEL STUDS @ 16" OC WITH STC 45 ONE LAYER OF 5/8" GWB ON EACH SIDE AND 3 1/2" 3# MINERAL WOOL SOUND ATTENUATION BATT BETWEEN STUDS. STEEL STUD PARTITION, RATED, INSULATED: S#R#N **S4R1N** | 3 5/8" STEEL STUDS @ 16" OC STC 45; 1-HR RATE WITH ONE LAYER OF 5/8" TYPE 'X' GWB ON EACH SIDE AND 3 1/2" 3# UL DESIGN MINERAL WOOL SOUND #U465 ATTENUATION BETWEEN STUDS. STEEL STUD ENCLOSURE: SE# 3 5/8" STEEL STUDS @ 16" OC WITH 5/8" GWB ON ONE SIDE. STEEL STUD ENCLOSURE, INSULATED: SE#N 3 5/8" STEEL STUDS @ 16" OC WITH 5/8" GWB ON ONE SIDE AND 3 1/2" 3# MINERAL WOOL SOUND ATTENUATION BATT BETWEEN STUDS. 362T150-43 TRACK XX.2 SECTION 'A-A' 362S162-43 STUD AT 16" OC CLARK DIETRICH 'MC973P' CFS CLIP WITH (6) #12 SCREWS, AT EACH STUD 1/2"Ø HILTI KWIK BOLT TZ WITH 2 3/4" EMBEDMENT **EXISTING CONCRETE SLAB GRAPHIC SCALE(S)** TYP ANCHORAGE OF PARTIAL HEIGHT PARTITION THAT SUPPORTS COUNTERTOP

DETAIL

PARTITION TYPES

STEEL STUD PARTITION: S#

TYPE DESCRIPTION

EACH SIDE.

3 5/8" STEEL STUDS @ 16" OC

WITH ONE LAYER OF 5/8" GWB ON

GENERAL NOTES

NOTES

REFER TO LIFE SAFETY PLAN FOR LOCATIONS OF EXISTING WALLS WITH HOURLY RATINGS. REPAIR ANY WALLS DAMAGED DURING DEMO OR NEW WORK TO MAINTAIN HOURLY RATING OF UL ASSEMBLY.

2. INSTALL ALL FIRE RATED WALL ASSEMBLIES IN STRICT ACCORDANCE WITH APPLICABLE CODES, ORDINANCE, OR LAWS AND UL DESIGN.

3. ALL PENETRATIONS IN EXISTING AND NEW RATED WALL ASSEMBLIES SHALL BE BY UL APPROVED FIRE RATED ASSEMBLIES.

4. ALL FIRE RATED AND SMOKE BARRIER PARTITIONS SHALL BE LABELED ABOVE CEILING WITH 1" MIN. TALL LETTERS AT NOT MORE THAN 8' - 0" OC WITH A MINIMUM 0.375 INCH STROKE. AN EXAMPLE LABEL IS AS FOLLOWS: "TWO HOUR FIRE BARRIER."

. IN CASES WHERE SOUND/FIRE/SMOKE RATED PARTITIONS ARE INTERRUPTED BY STRUCTURAL MEMBERS. MAINTAIN RATING AROUND OBSTRUCTION.

6. SOUND TRANSMISSION CLASS (STC) RATINGS ARE APPROXIMATE LABORATORY TESTED LEVELS. STC RATINGS ARE PROVIDED FOR GENERAL DESCRIPTION OF CONSTRUCTION ONLY. STC RATINGS TESTED IN THE FIELD MAY BE LESS THAN LABORATORY TESTED STC RATINGS.

USE SOUND RATED SEALANT AT THE HEAD AND BASE OF TRACKS OF ALL STC RATED PARTITIONS.

8. PARTITION DIMENSIONING AND PARTITION TYPE DESIGNATIONS ARE INDEPENDENT OF APPLIED FINISHES. REFER TO FINISH SCHEDULE FOR INFORMATION REGARDING APPLIED FINISHES.

9. PROVIDE GLASS-MAT, WATER RESISTANT BACKING BOARD AT PARTITIONS TO RECEIVE CERAMIC TILE.

10. METAL STUD GAUGE AND SPACING TO BE DETERMINED BY METAL STUD MANUFACTURER GUIDELINES AND TEST REPORTS IN ORDER TO MEET THE FOLLOWING PERFORMANCE REQUIREMENTS FOR HORIZONTAL DEFLECTION, UON IN THE SPECIFICATIONS.

A. TYPICAL PARTITION STUD GAUGE SHALL BE DESIGNED TO AN L/120 DEFLECTION OR LESS AS REQUIRED BY CODE, UON.

B. ON PARTITIONS TO RECEIVE TILE, PARTITION STUD GAUGE SHALL BE DESIGNED TO AN L/360 DEFLECTION OR LESS AS RECOMMENDED BY THE TILE COUNCIL OF NORTH AMERICA.

EVMS GYNECOLOGY

HOFHEIMER HALL **SECOND FLOOR RENOVATION**

825 FAIRFAX AVENUE NORFOLK, VA 23507

DESIGNER

CLARKNEXSEN

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PROFESSIONAL SEAL

SUBMITTAL

03/26/24

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RATED PARTITION LEGEND

WALL TYPE DESIGNATOR FULL HEIGHT PARTITION FROM FLOOR SLAB TO UNDERSIDE OF XX STRUCTURE ABOVE.

EXTEND PARTITION FROM FLOOR SLAB TO 6" ABOVE CEILING.

SEE DETAIL A1/AE501. SEE A3/AE501 FOR ANCHORAGE OF PARTIAL HEIGHT PARTITIONS SUPPORTING COUNTERTOPS.


PARTITION TYPES AND **DETAILS**

AE501

DESIGN: DLS DRAWN: TSM REVIEW: DLS

BULKHEAD DETAIL SCALE: 1 1/2" = 1'-0"

- 2 1/2" MTL STUD BRACING @ 4'-0" OC MAX - COLD ROLLED STL ANGLE CONT BACKER ROD AND SEALANT JOINT SEE RCP AFF CONT 1 1/2" x 1 1/2" COLD ROLLED STL ANGLE, TYP - 5/8" GWB ON SUSPENSION FRAMING @ 24" OC 5/8" GWB ON 2 1/2" MTL STUDS @ 16" OC MAX — - 5/8" GWB ON 2 1/2" MTL STUDS @ 16" OC MAX ATTACHED TO STRUCTURE ABOVE, TYP VARIES SEE RCP CONDITION AT GWB CEILING WHERE SCHEDULED CONDITION AT ACT CEILING WHERE SCHEDULED WIDE BULKHEAD DETAIL B4 WIDE BULK
SCALE: 1 1/2" = 1'-0"

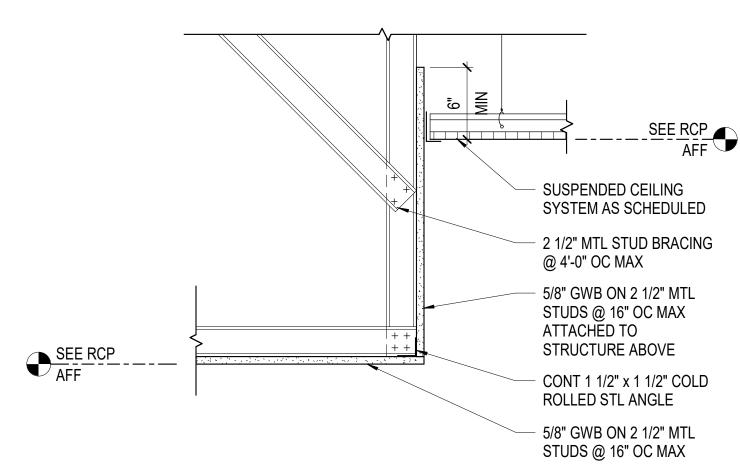

SOFFIT DETAIL

SCALE: 1 1/2" = 1'-0"

GRAPHIC SCALE(S)

EVMS GYNECOLOGY

HOFHEIMER HALL SECOND FLOOR RENOVATION

825 FAIRFAX AVENUE NORFOLK, VA 23507

DESIGNER

SEE RCP AFF

SUSPENDED CEILING
 SYSTEM AS SCHEDULED,

- 3 5/8" MTL STUD BRACING

- 5/8" GWB ON 3 5/8" MTL STUDS @ 16" OC MAX ATTACHED TO STRUCTURE ABOVE

- CONT 1 1/2" x 1 1/2" COLD ROLLED STL ANGLE, TYP

@ 4'-0" OC MAX

CLARKNEXSEN

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PROFESSIONAL SEAL

SUBMITTAL 03/26/24 FINAL SUBMITTAL

REVISIONS


SHEET **CEILING DETAILS**


AE502

DESIGN: DLS DRAWN: TSM REVIEW: DLS


CN 10376

RECEPTION BULKHEAD

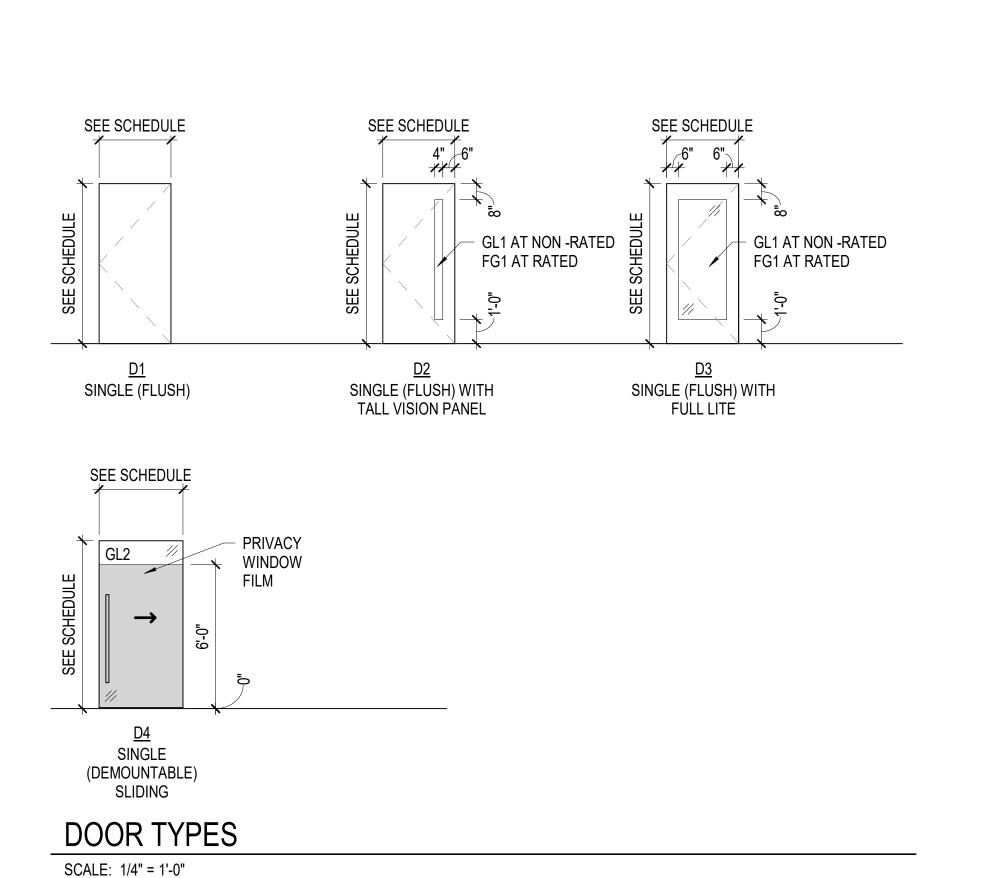

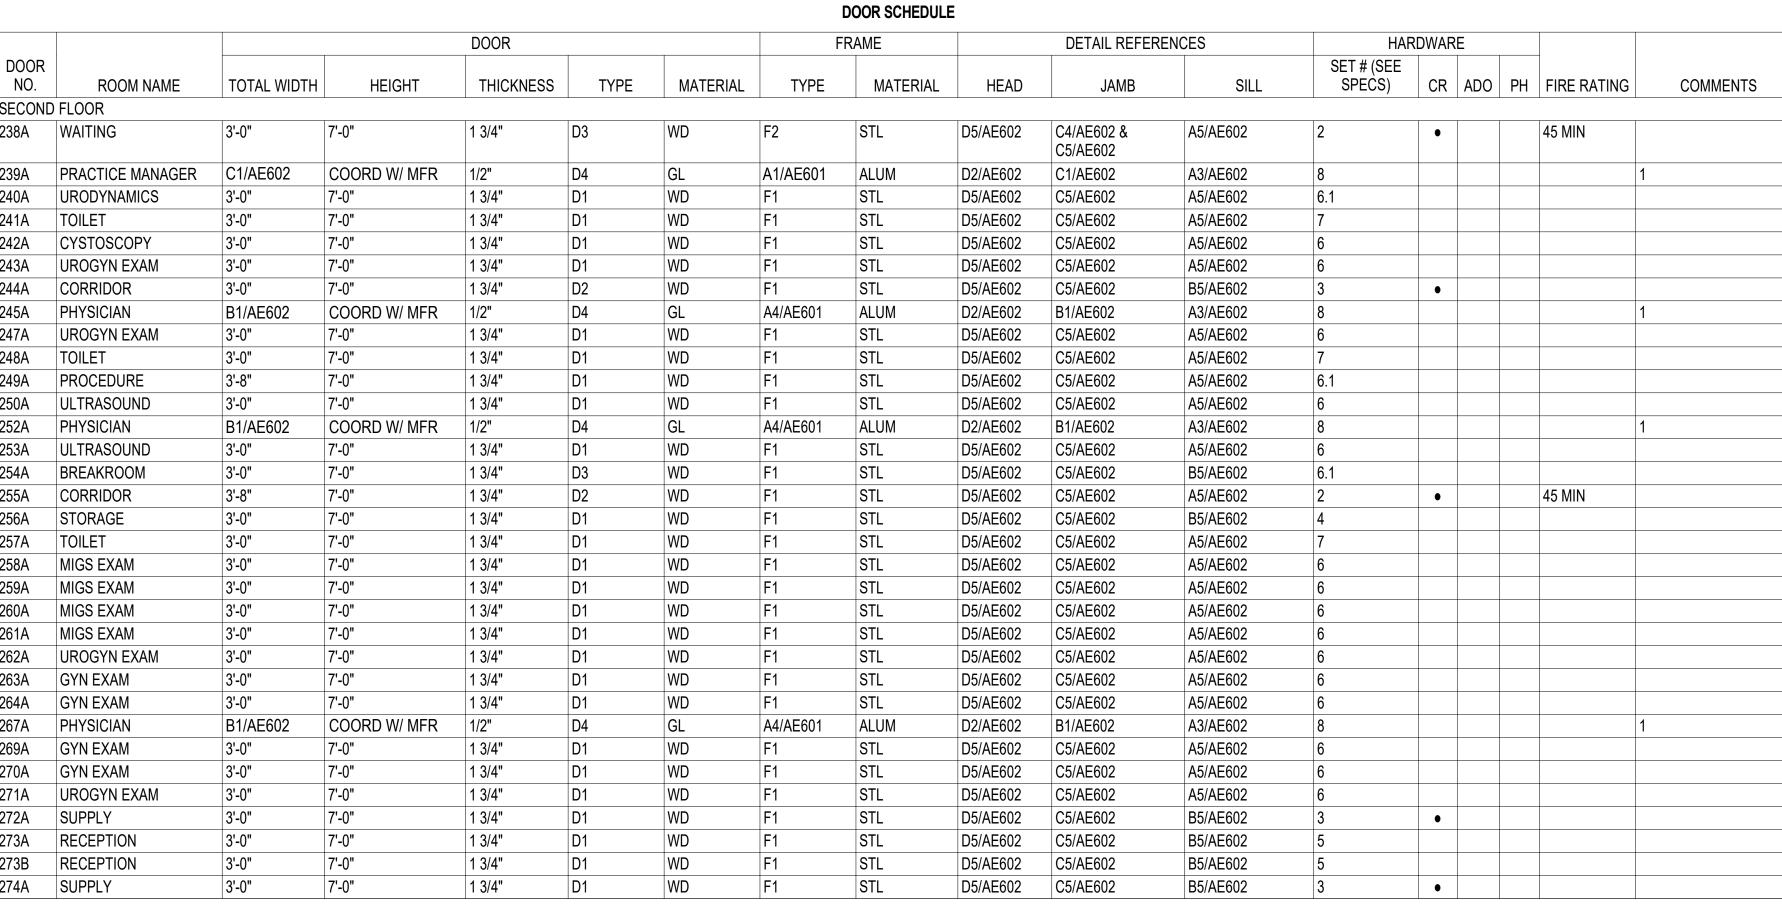


DOOR SECOND FLOOR 238A 239A 241A 242A 252A 256A 260A 270A 272A 273B 274A SUPPLY

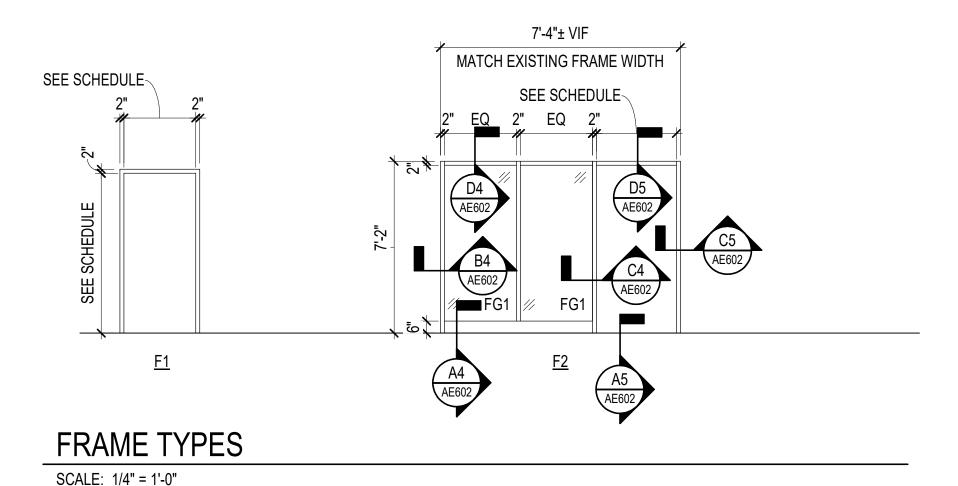

DF1 WINDOW FILM

DOOR SCHEDULE COMMENTS: 1. LOCKABLE DOOR WITH SUB-MASTER KEYING SYSTEM.

	GLAZING SCHEDULE	
TYPE	THICKNESS	
FG1	1/4" CLEAR FIRE PROTECTION-RATED SAFETY GLAZING - 45 MIN	
GL1	1/4" CLEAR SAFETY GLAZING	
GL2	1/2" CLEAR SAFETY GLAZING	

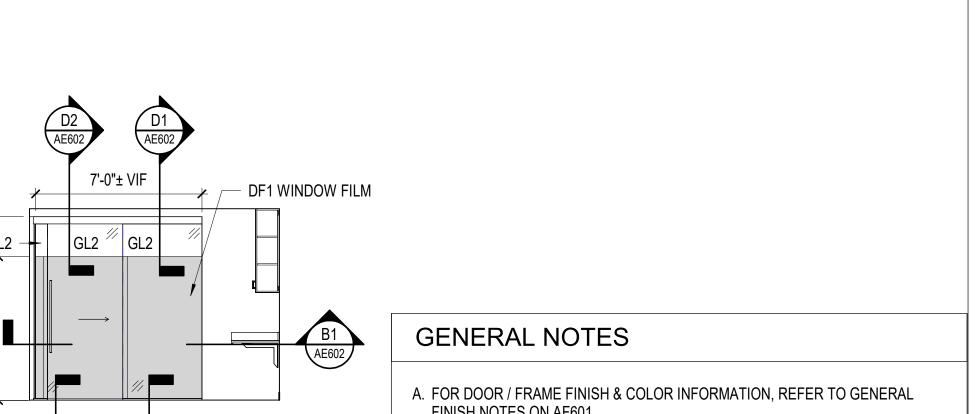

FINISH NOTES ON AF601.

GRAPHIC SCALE(S)

AE601

FRAME TYPES

EVMS GYNECOLOGY

HOFHEIMER HALL

CLARKNEXSEN

4525 MAIN STREET, SUITE 1400

VIRGINIA BEACH, VIRGINIA 23462

SECOND FLOOR

RENOVATION

825 FAIRFAX AVENUE

NORFOLK, VA 23507

DESIGNER

757-455-5800

PROFESSIONAL SEAL

SUBMITTAL

03/26/24

FINAL SUBMITTAL

CN 10376

DEMOUNTABLE PARTITON - RM 239 SCALE: 1/4" = 1'-0"

DEMOUNTABLE PARTITION

6'-11"± VIF-

EQ

GL2

A1 AE602

GL2

DF1 WINDOW FILM

DEMOUNTABLE PARTITION W/ WING WALL


SCALE: 1/4" = 1'-0" SCALE: 1/4" = 1'-0"


DF1 WINDOW FILM

DEMOUNTABLE PARTITION


DESIGN: DLS DRAWN: TSM REVIEW: DLS

DOOR SCHEDULE AND DOOR /

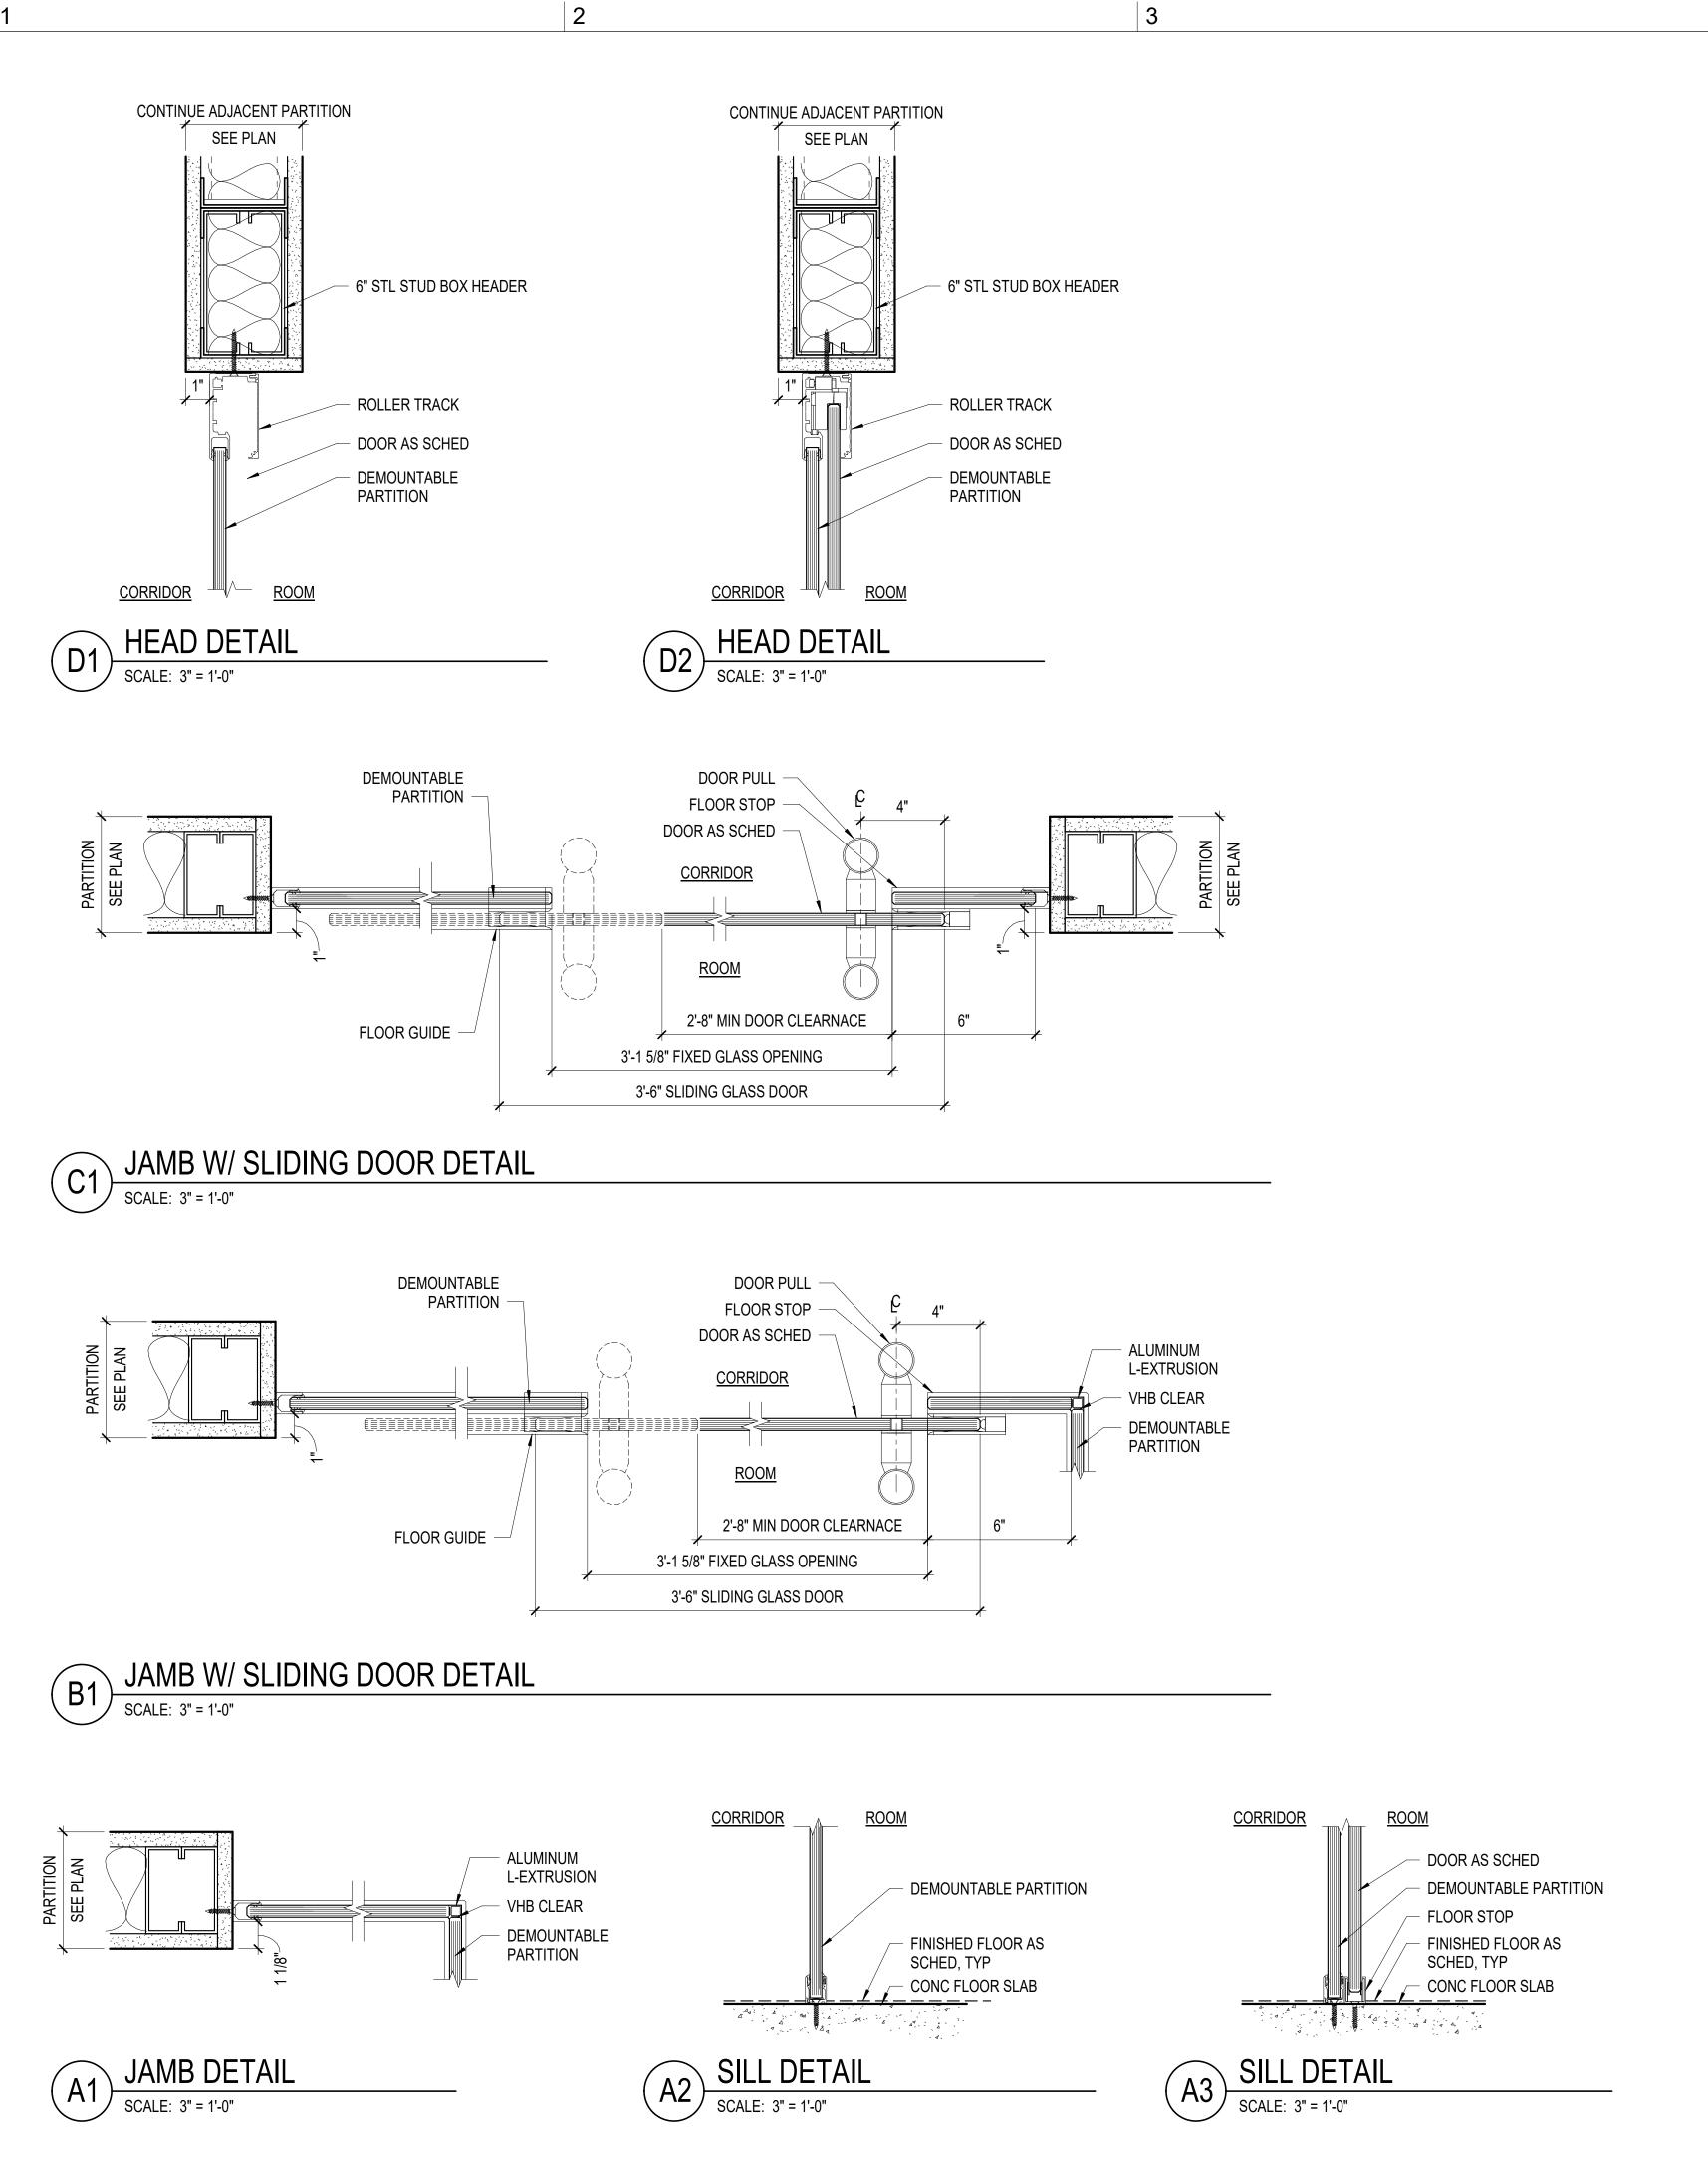


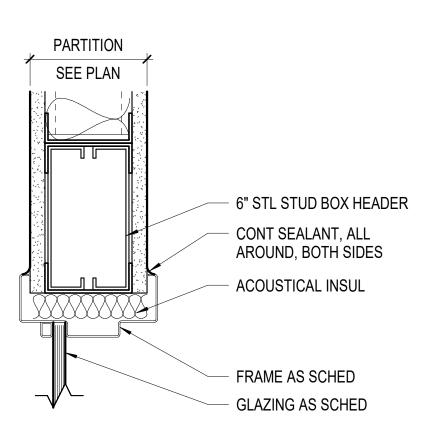

HEAD DETAIL SCALE: 3" = 1'-0"

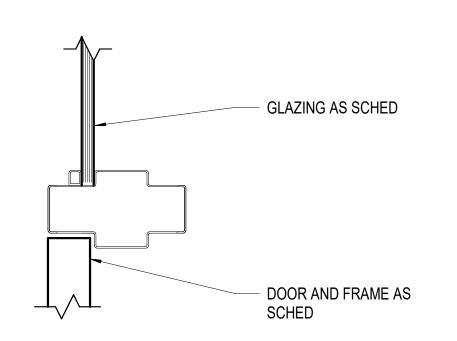


, JAMB DETAIL SCALE: 3" = 1'-0"

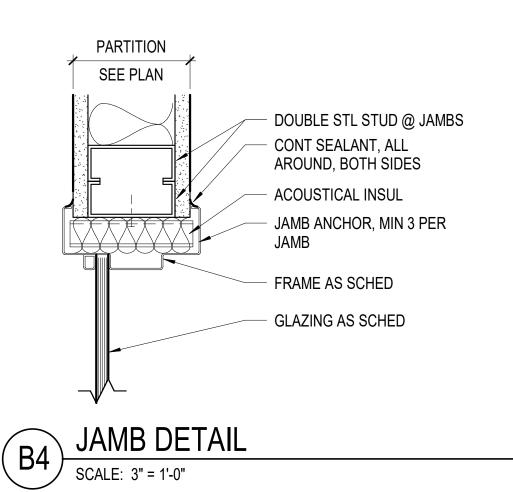


GLAZING AS SCHED FLOOR FINISH AS SCHED, TYP CONC FLOOR SLAB

SILL DETAIL


SCALE: 3" = 1'-0"

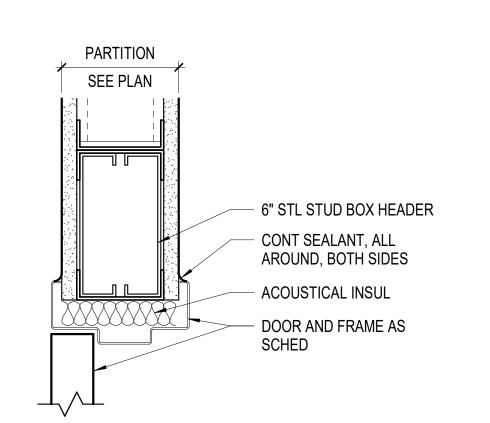


HEAD DETAIL SCALE: 3" = 1'-0"

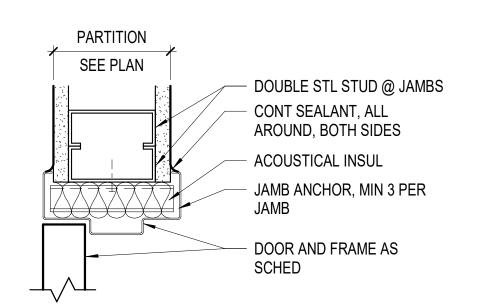

JAMB DETAIL SCALE: 3" = 1'-0"

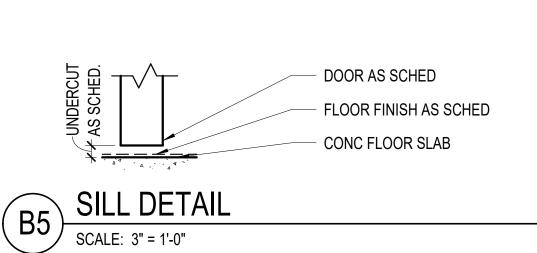

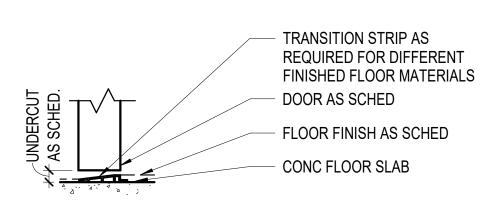

SILL DETAIL

SCALE: 3" = 1'-0"

GRAPHIC SCALE(S)

SHEET DOOR DETAILS

EVMS GYNECOLOGY

HOFHEIMER HALL

CLARKNEXSEN

4525 MAIN STREET, SUITE 1400

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SECOND FLOOR

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DESIGNER

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PROFESSIONAL SEAL

SUBMITTAL

03/26/24

REVISIONS

FINAL SUBMITTAL

AE602

DESIGN: DLS DRAWN: TSM REVIEW: DLS